3200 N TILLOTSON AVE, MUNCIE, IN 47306

MSA \ SPORT

## BID/PERMIT SET - 11/21/2025

OWNER:

## **BALL STATE UNIVERSITY**

2000 W. UNIVERSITY AVE (AD 208) MUNCIE, IN 47306 www.bsu.edu

## **ARCHITECT:**

**MSA SPORT** 316 W. FOURTH STREET 6TH FLOOR CINCINNATI, OH 45202 (T): (513) 241-5666 www.msaarch.com

## **MEP ENGINEER:**

**LOFTUS ENGINEERING** 201 SOUTH CAPITOL AVE, SUITE 310 INDIANAPOLIS, IN 46225 (T): (317) 352-5822 www.loftusengineering.com

## **CIVIL ENGINEER:**

**ETICA GROUP** 8720 CASTLE CREEK PKWY E. SUITE 400 INDIANAPOLIS, IN 46250

(T): (317) 466-9520 www.eticagroup.com

## STRUCTURAL ENGINEER:

## JULIE CROMWELL & ASSOCIATES

7140 MIAMI AVE CINCINNATI, OH 45243 (T): (513) 321-2555 www.juliecromwell.com

## PROJECT DESCRIPTION

PROJECT SCOPE: THIS PROJECT INVOLVES THE CREATION OF TWO (2) STAND-ALONE LOCKER ROOM BUILDINGS, ONE EACH FOR BASEBALL & SOFTBALL AT SHEBEK STADIUM & BALL STATE SOFTBALL STADIUM, RESPECTIVELY. EACH BUILDING INCLUDES HOME TEAM LOCKER ROOMS (FOR PLAYERS & COACHES), A PLAYER LOUNGE & NUTRITION AREA, AND ASSOCIATED ATHLETIC AND ADMINISTATION FACILITIES. THE PROJECT ALSO INVOLVES ASSOCIATED SITE WORK AT EACH BUILDING, INCLUDING NEW ACCESS STAIRS LEADING TO THE HOME DUGOUTS FOR EACH TEAM.


## **GENERAL NOTES:**

1. BOTH THE BASEBALL & SOFTBALL BUILDINGS ARE INDEPENDENT AND NOT RELATED IN ELEVATION OR GRADING. FOR COORDINATION, ARCHITECTURAL DRAWINGS REFERENCE FFE = 100'-0" FOR EACH BUIDLING. ACTUAL CIVIL ELEVATIONS ARE: BASEBALL FFE = 943.20' & SOFTBALL FFE = 943.70'. REFER TO CIVIL DRAWINGS FOR TRUE SITE ELEVATIONS.


2. COORDINATE CONSTRUCTION SCHEDULE DURING SEASON WITH ATHLETIC DEPARTMENT. IMPLIMENT NOISE CONSTRICTION DURING HOME GAMES. ALTERNATE 1: SOFTBALL AND BASEBALL ENCLOSED PRE-FABRICATED FREE STANDING WALKWAY CANOPY, B.O.D. UPSIDE INNOVATIONS, SUBJECT TO CHANGE.

ALTERNATE 2: CUSTOM CARPET BALL STATE CARDINAL LOGO TO BE INSET WITHIN CPT-1. ARTWORK TO BE PROVIDED BY OWNER. FINAL SIZE & COLORS TO BE APPROVED BY ARCHITECT AND OWNER. ALTERNATE 3: PLAYER LOCKERS TO INCLUDE DOORS ON FRONT ELEVATIONS PER DETAILS. PROVIDE SEPERATE PRICING FOR BASEBALL AND SOFTBALL LOCKERS.


## **EXTERIOR PERSPECTIVES**

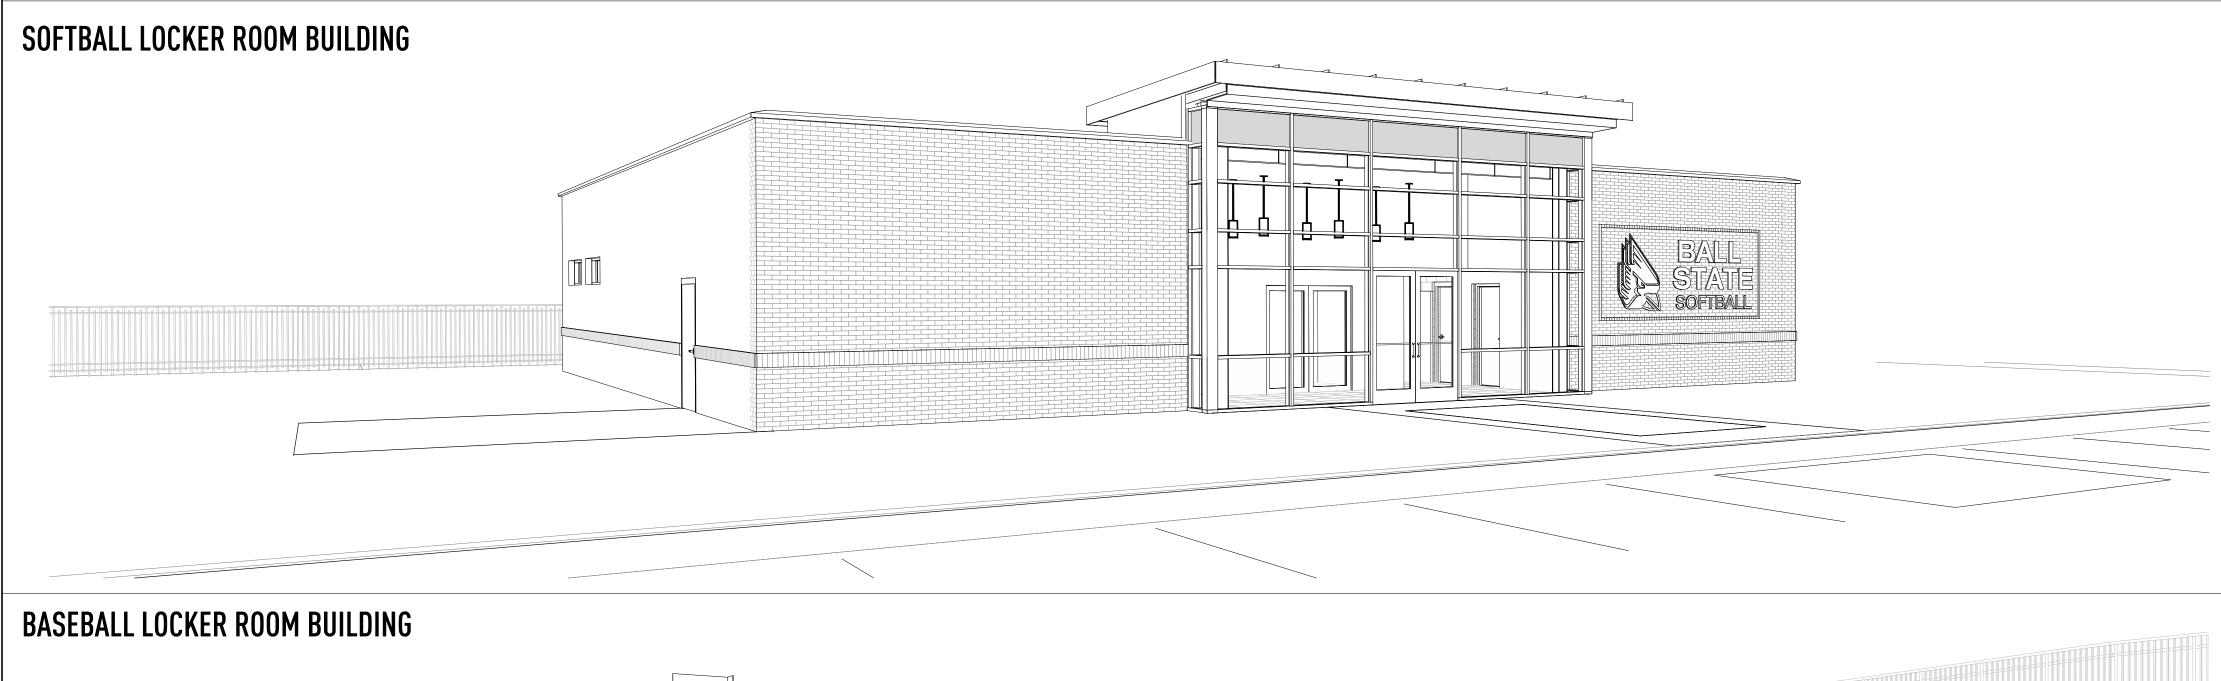




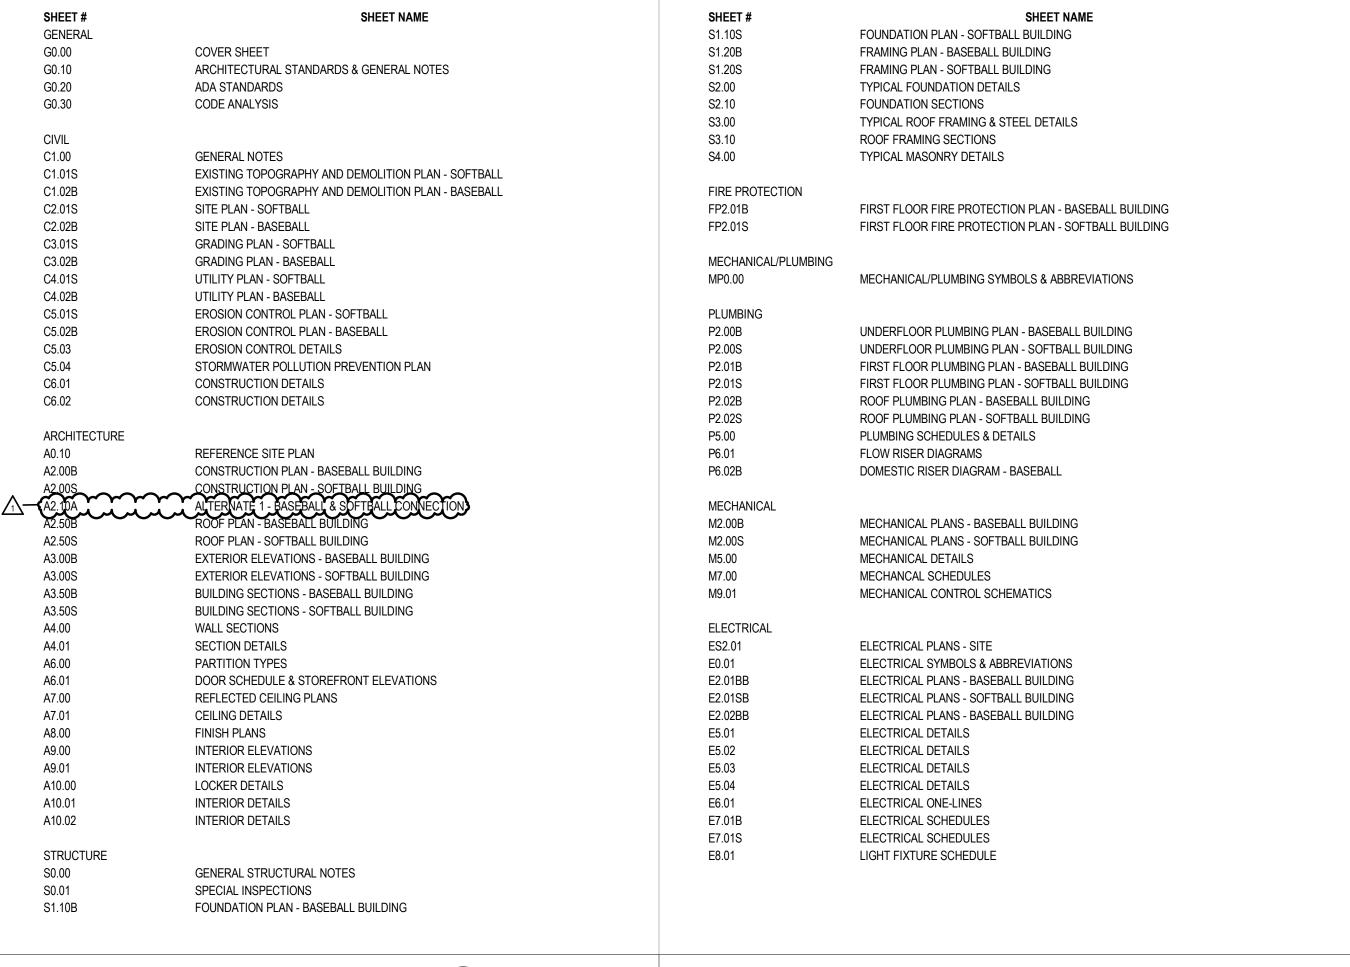

**SHEET INDEX** 

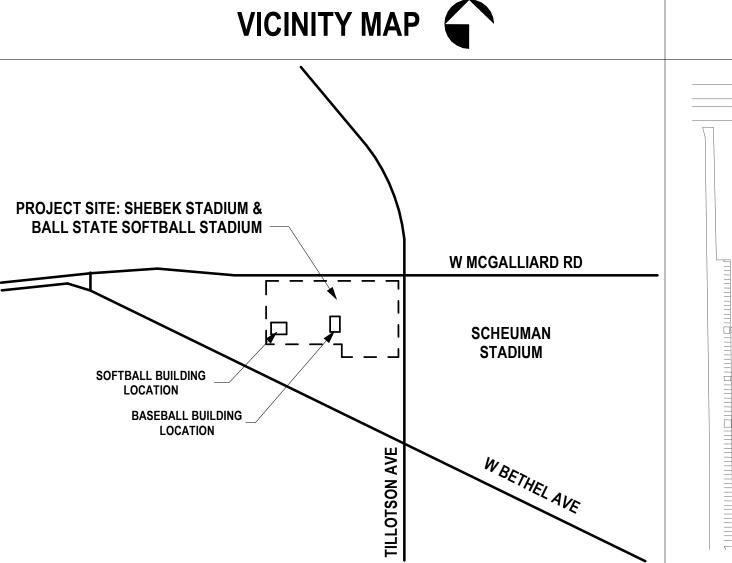

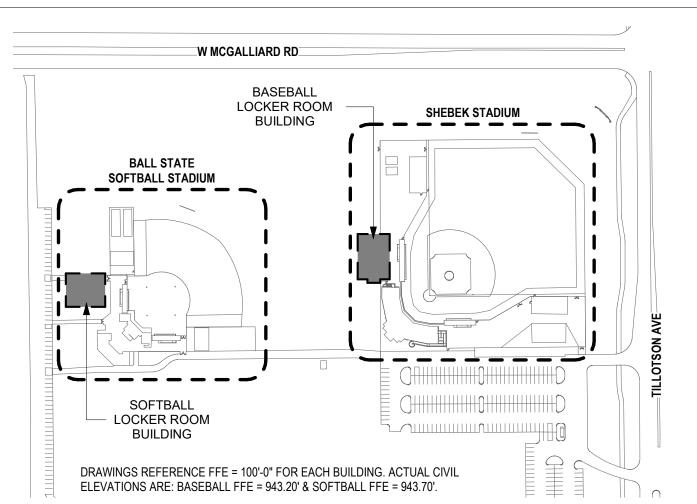

**KEY PLAN** 


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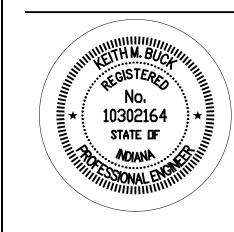
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PROJECT NO. DRAWING TITLE: **COVER SHEET** 



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SEBALL & SOFTBALL LOCKER ROOM BUILDING

47

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1 12/15/2025 ADDENDUM #2

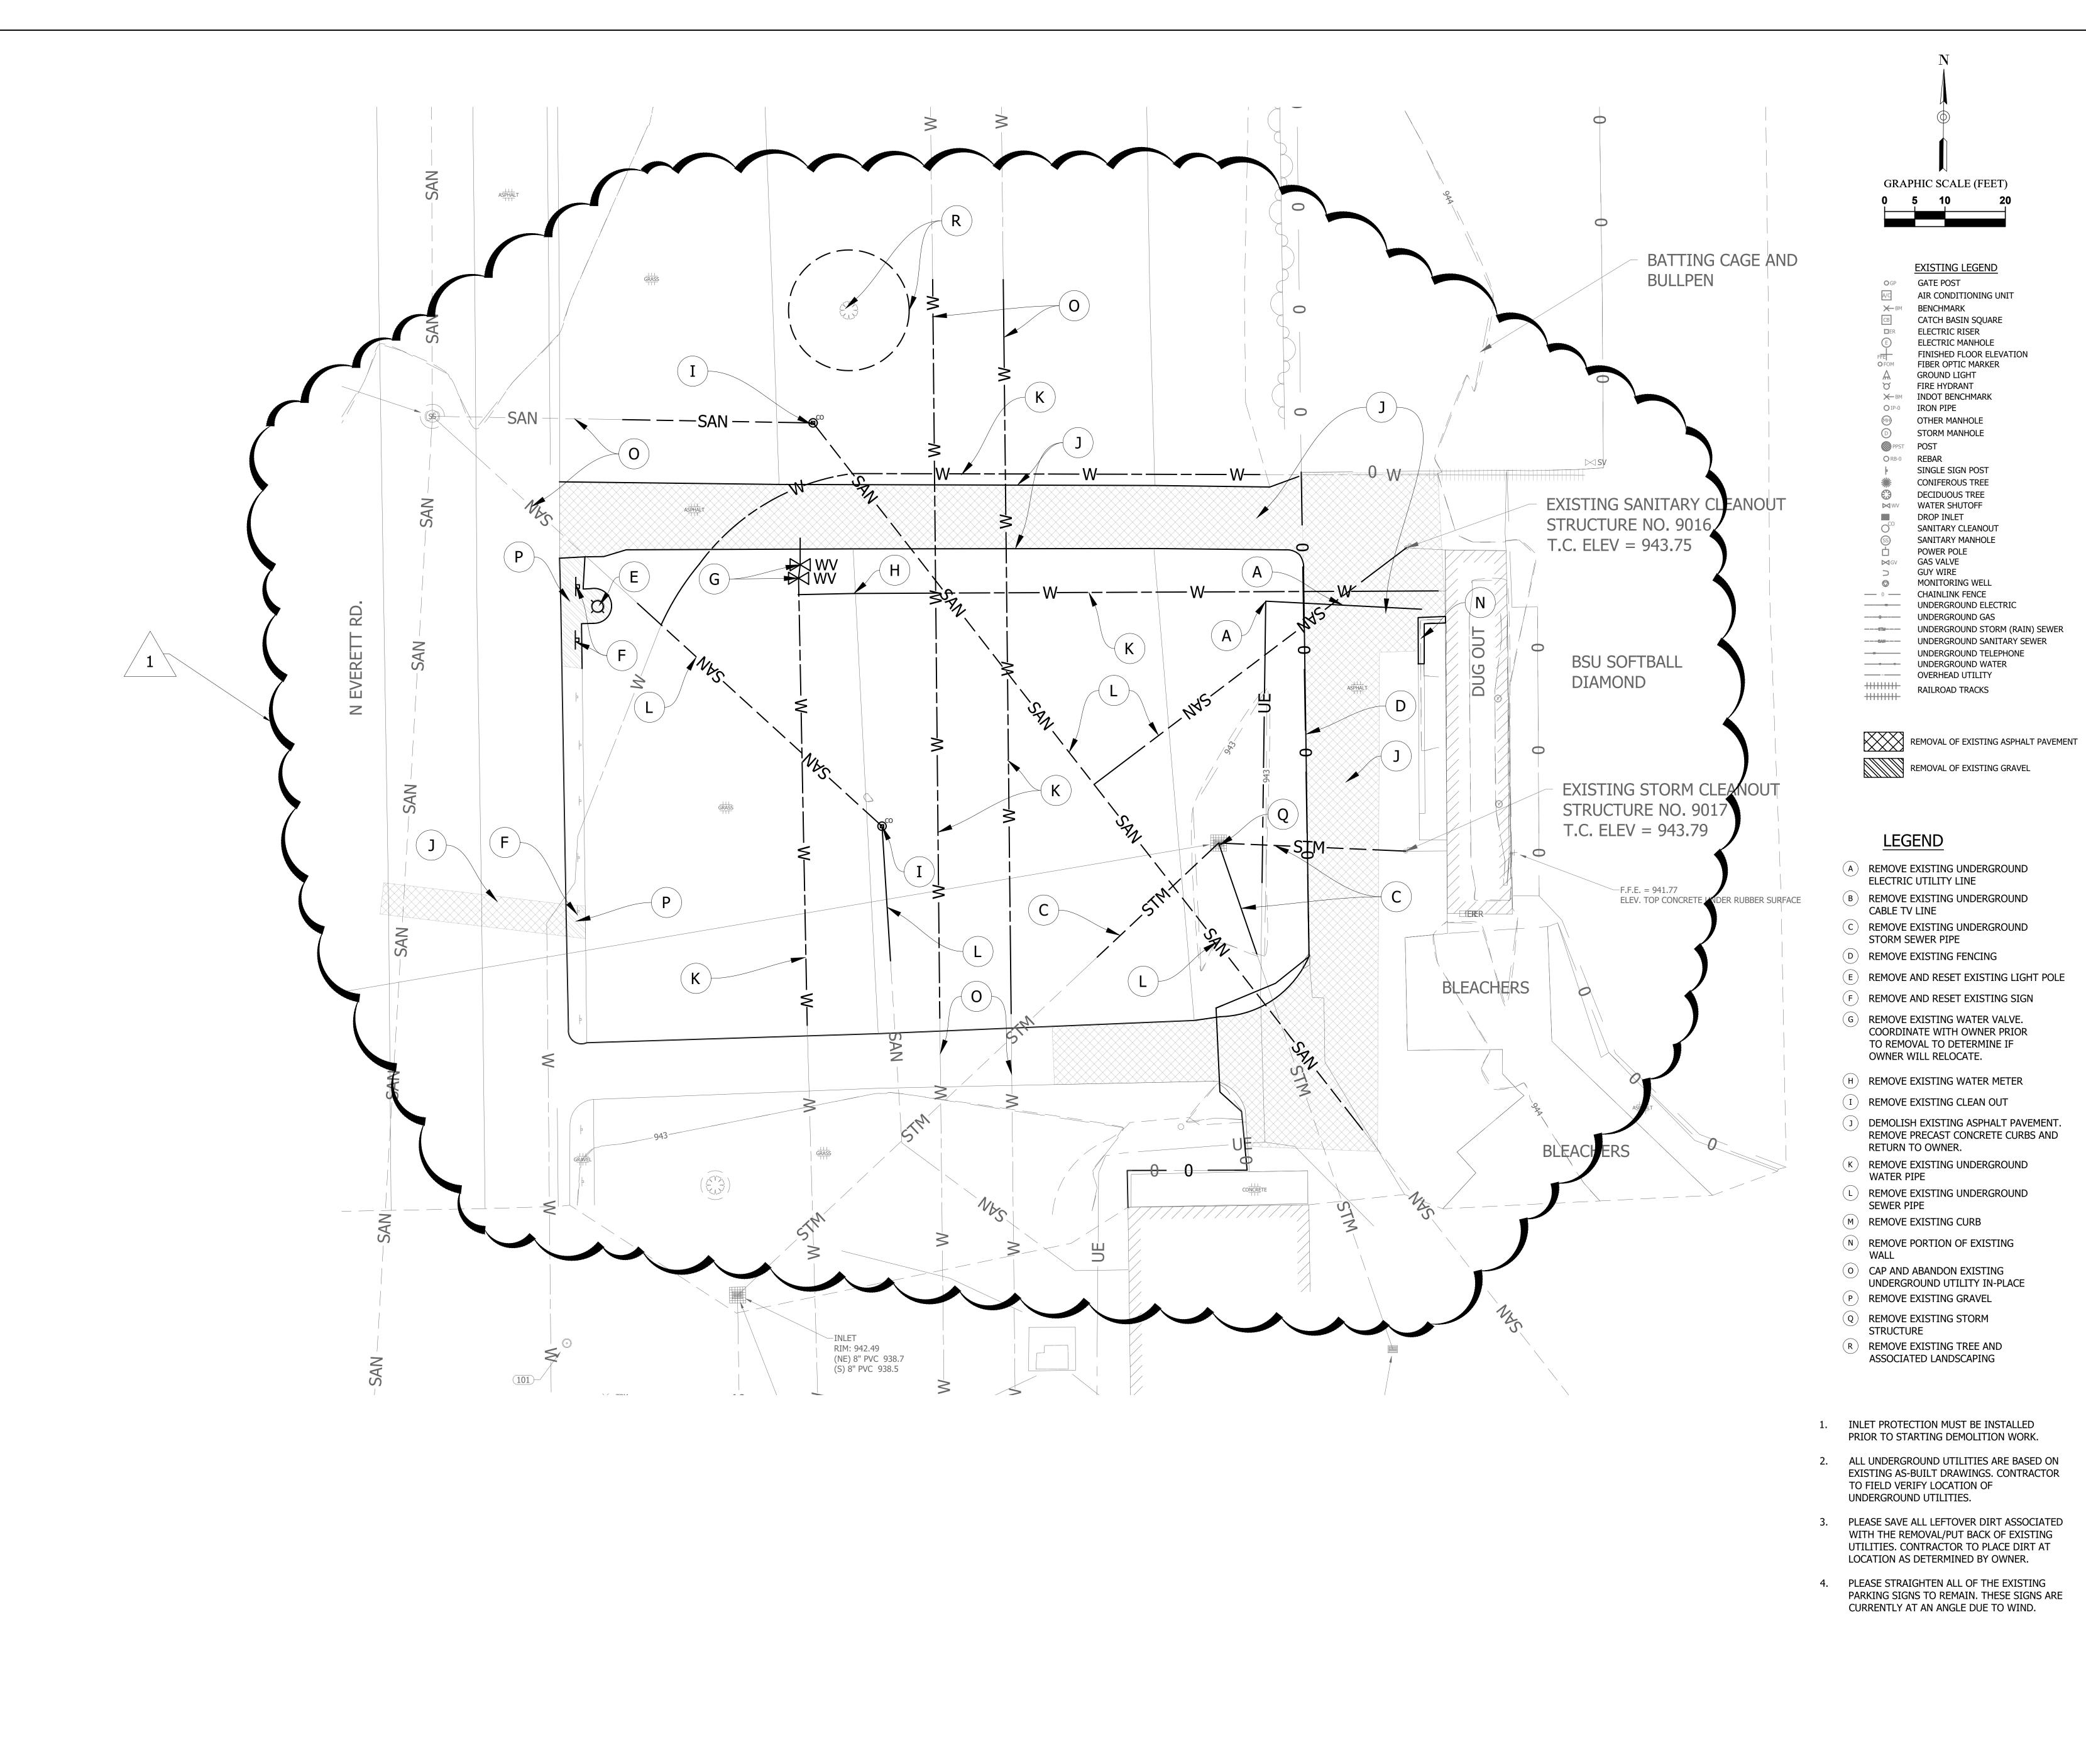PROJECT NO. 24104.00

DRAWING TITLE:


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TOPOGRAPHY AND

DEMOLITION PLAN -

SOFTBALL

C1.01S

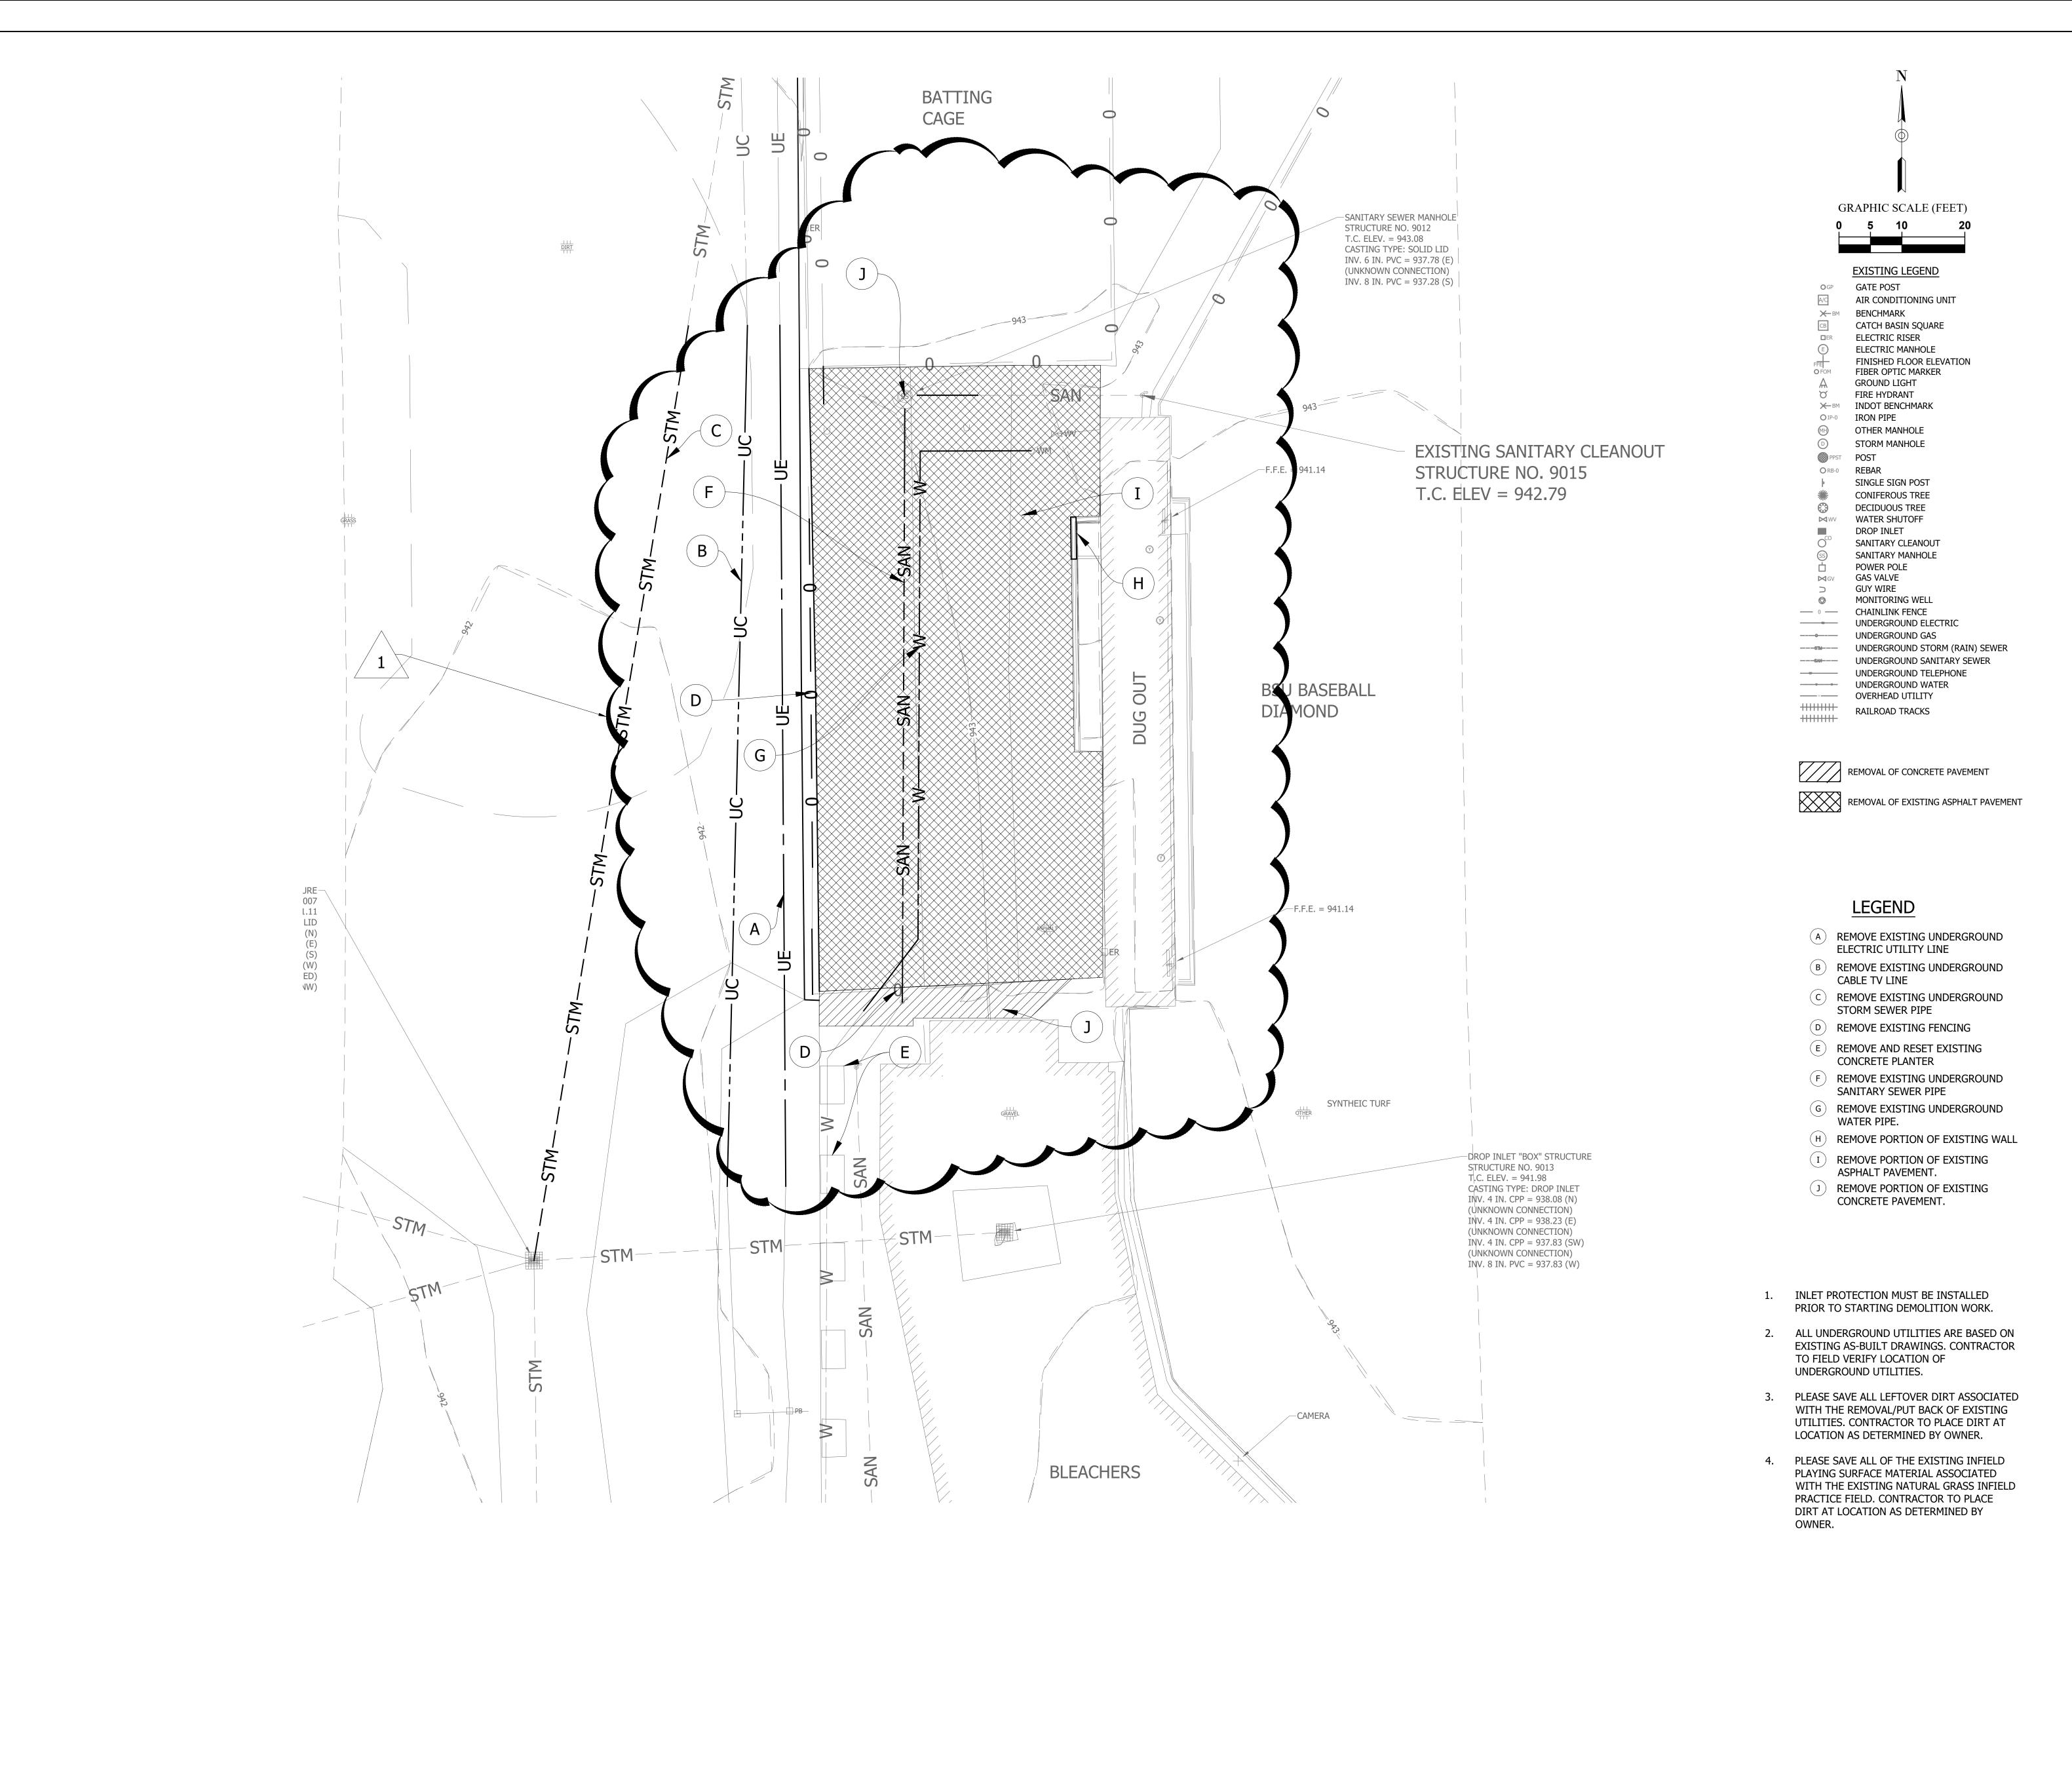

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& SOFTBALL LOCKER ROOM BUILDING

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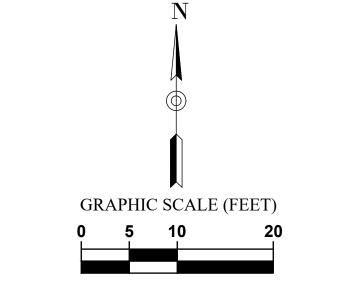
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DRAWING TITLE:

EXISTING

DRAWING TITLE:
EXISTING
TOPOGRAPHY AND
DEMOLITION PLAN BASEBALL

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## CINCINNATI | COLUMBUS | ORLANDO msaarch.com | 855,241,5666 STATE OF

BUILDING

LOCKER

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## SITE WORK GENERAL NOTES AND SPECIFICATIONS

- 1. THE CONTRACTOR SHALL BE RESPONSIBLE FOR OBTAINING, OR VERIFYING, THAT ALL PERMITS AND APPROVALS ARE OBTAINED FROM THE RESPECTIVE CITY, COUNTY, STATE AND ANY OTHER REGULATORY AGENCIES PRIOR TO STARTING CONSTRUCTION.
- 2. EXISTING UTILITY LOCATIONS ARE APPROXIMATE. THE CONTRACTOR SHALL DETERMINE AND FIELD VERIFY ALL HORIZONTAL AND VERTICAL LOCATIONS PRIOR TO COMMENCEMENT OF
- 3. IT SHALL BE THE RESPONSIBILITY OF THE CONTRACTOR TO NOTIFY AND OBTAIN APPROVAL FROM EACH RESPECTIVE UTILITY COMPANY PRIOR TO PERFORMING ANY WORK ON OR IN THE VICINITY OF EXISTING UTILITIES LINES AND APPURTENANCES.
- 4. IT SHALL BE THE RESPONSIBILITY OF THE DEVELOPER AND CONTRACTOR TO MAINTAIN QUALITY CONTROL THROUGHOUT THE PROJECT; FAILURE TO DO SO MAY RESULT IN REMOVAL AND REPLACEMENT OF THE DEFECTIVE WORK. IT IS RECOMMENDED THAT THE DEVELOPER
- HAVE A QUALIFIED INSPECTOR ON THE JOB SITE AT ALL TIMES DURING CONSTRUCTION. 5. ALL QUANTITIES GIVEN ON THE PRINTS, VERBALLY OR IN THE SCOPE OF WORK SECTION ARE ESTIMATES AND SHALL BE CONFIRMED BY THE BIDDING CONTRACTOR.
- 6. OCCUPATIONAL SAFETY AND HEALTH ADMINISTRATION (OSHA) STANDARDS FOR EXCAVATIONS FINAL RULE 29 CFR PART 1926, SUBPART "P" APPLIES TO ALL EXCAVATIONS EXCEEDING
- EXCAVATIONS EXCEEDING TWENTY (20) FEET IN DEPTH REQUIRE THE DESIGN OF A TRENCH SAFETY SYSTEM BY A REGISTERED PROFESSIONAL ENGINEER.

## SITE PLAN NOTES

- 1. ALL RADII AND STREET DIMENSIONS SHALL BE MEASURED TO BACK OF CURB OR FACE OF INTEGRAL CURB AND WALK. ALL DIMENSIONS TO THE BUILDING ARE TO THE OUTSIDE OF BUILDING FOUNDATION WALL.
- 2. ALL PAVEMENT AND/OR CURB RADII TO BE FIVE (5) FOOT UNLESS OTHERWISE NOTED.
- 3. BEARINGS, DIMENSIONS AND EASEMENTS ARE SHOWN FOR REFERENCE ONLY. REFER TO RECORDED BOUNDARY SURVEYS, ALTAS AND SECONDARY PLATS FOR EXACT INFORMATION.

4. REFER TO ARCHITECTURAL PLANS FOR DETAILS OF BUILDINGS AND BUILDING DIMENSIONS.

- 5. TEMPORARY TRAFFIC CONTROL DURING CONSTRUCTION SHALL CONFORM TO APPLICABLE LOCAL STANDARDS.
- 6. REFER TO UTILITY PLAN FOR SANITARY AND STORM STRUCTURE LOCATIONS.
- 7. ANY DISCREPANCIES OR CONFLICTS WHICH BECOME APPARENT BEFORE OR DURING CONSTRUCTION SHALL BE BROUGHT TO THE ATTENTION OF THE ENGINEER OF RECORD IMMEDIATELY SO THAT CLARIFICATION OR REDESIGN MAY OCCUR.

## **LEGEND**

- 4" CONCRETE SIDEWALK. ADJUST EDGE OF EXISTING ASPHALT PAVING ACCORDING TO CREATE A STRAIGHT AND
- PLUMB TRANSITION. INSTALL CONTINUOUS EXPANSION JOINT BETWEEN EXISTING HARD SURFACE AND CONCRETE.
- INDOT #53 STONE TO MATCH EXISTING ADJACENT STONE
- ASPHALT PAVEMENT
- BRICK SIDEWALK. SEE ARCHITECTURE DETAILS.
- NEW FENCING TO MATCH ADJACENT EXISTING FENCE
- NEW STEPS TO DUGOUT. SEE STRUCTURAL DETAILS.
- TRENCH PATCH. SEE SHEET C401.
- (I) 6" CONCRETE PAD
- NEW FENCING. SEE
- ARCHITECTURAL PLANS RESET EXISTING SIGN
- NEW COVERED WALKWAY. SEE ARCHITECTURE DETAILS.

PROPOSED BRICK WALK

PROPOSED CONCRETE PAVEMENT

PROPOSED ASPHALT WALK

PROPOSED TRENCH PATCH

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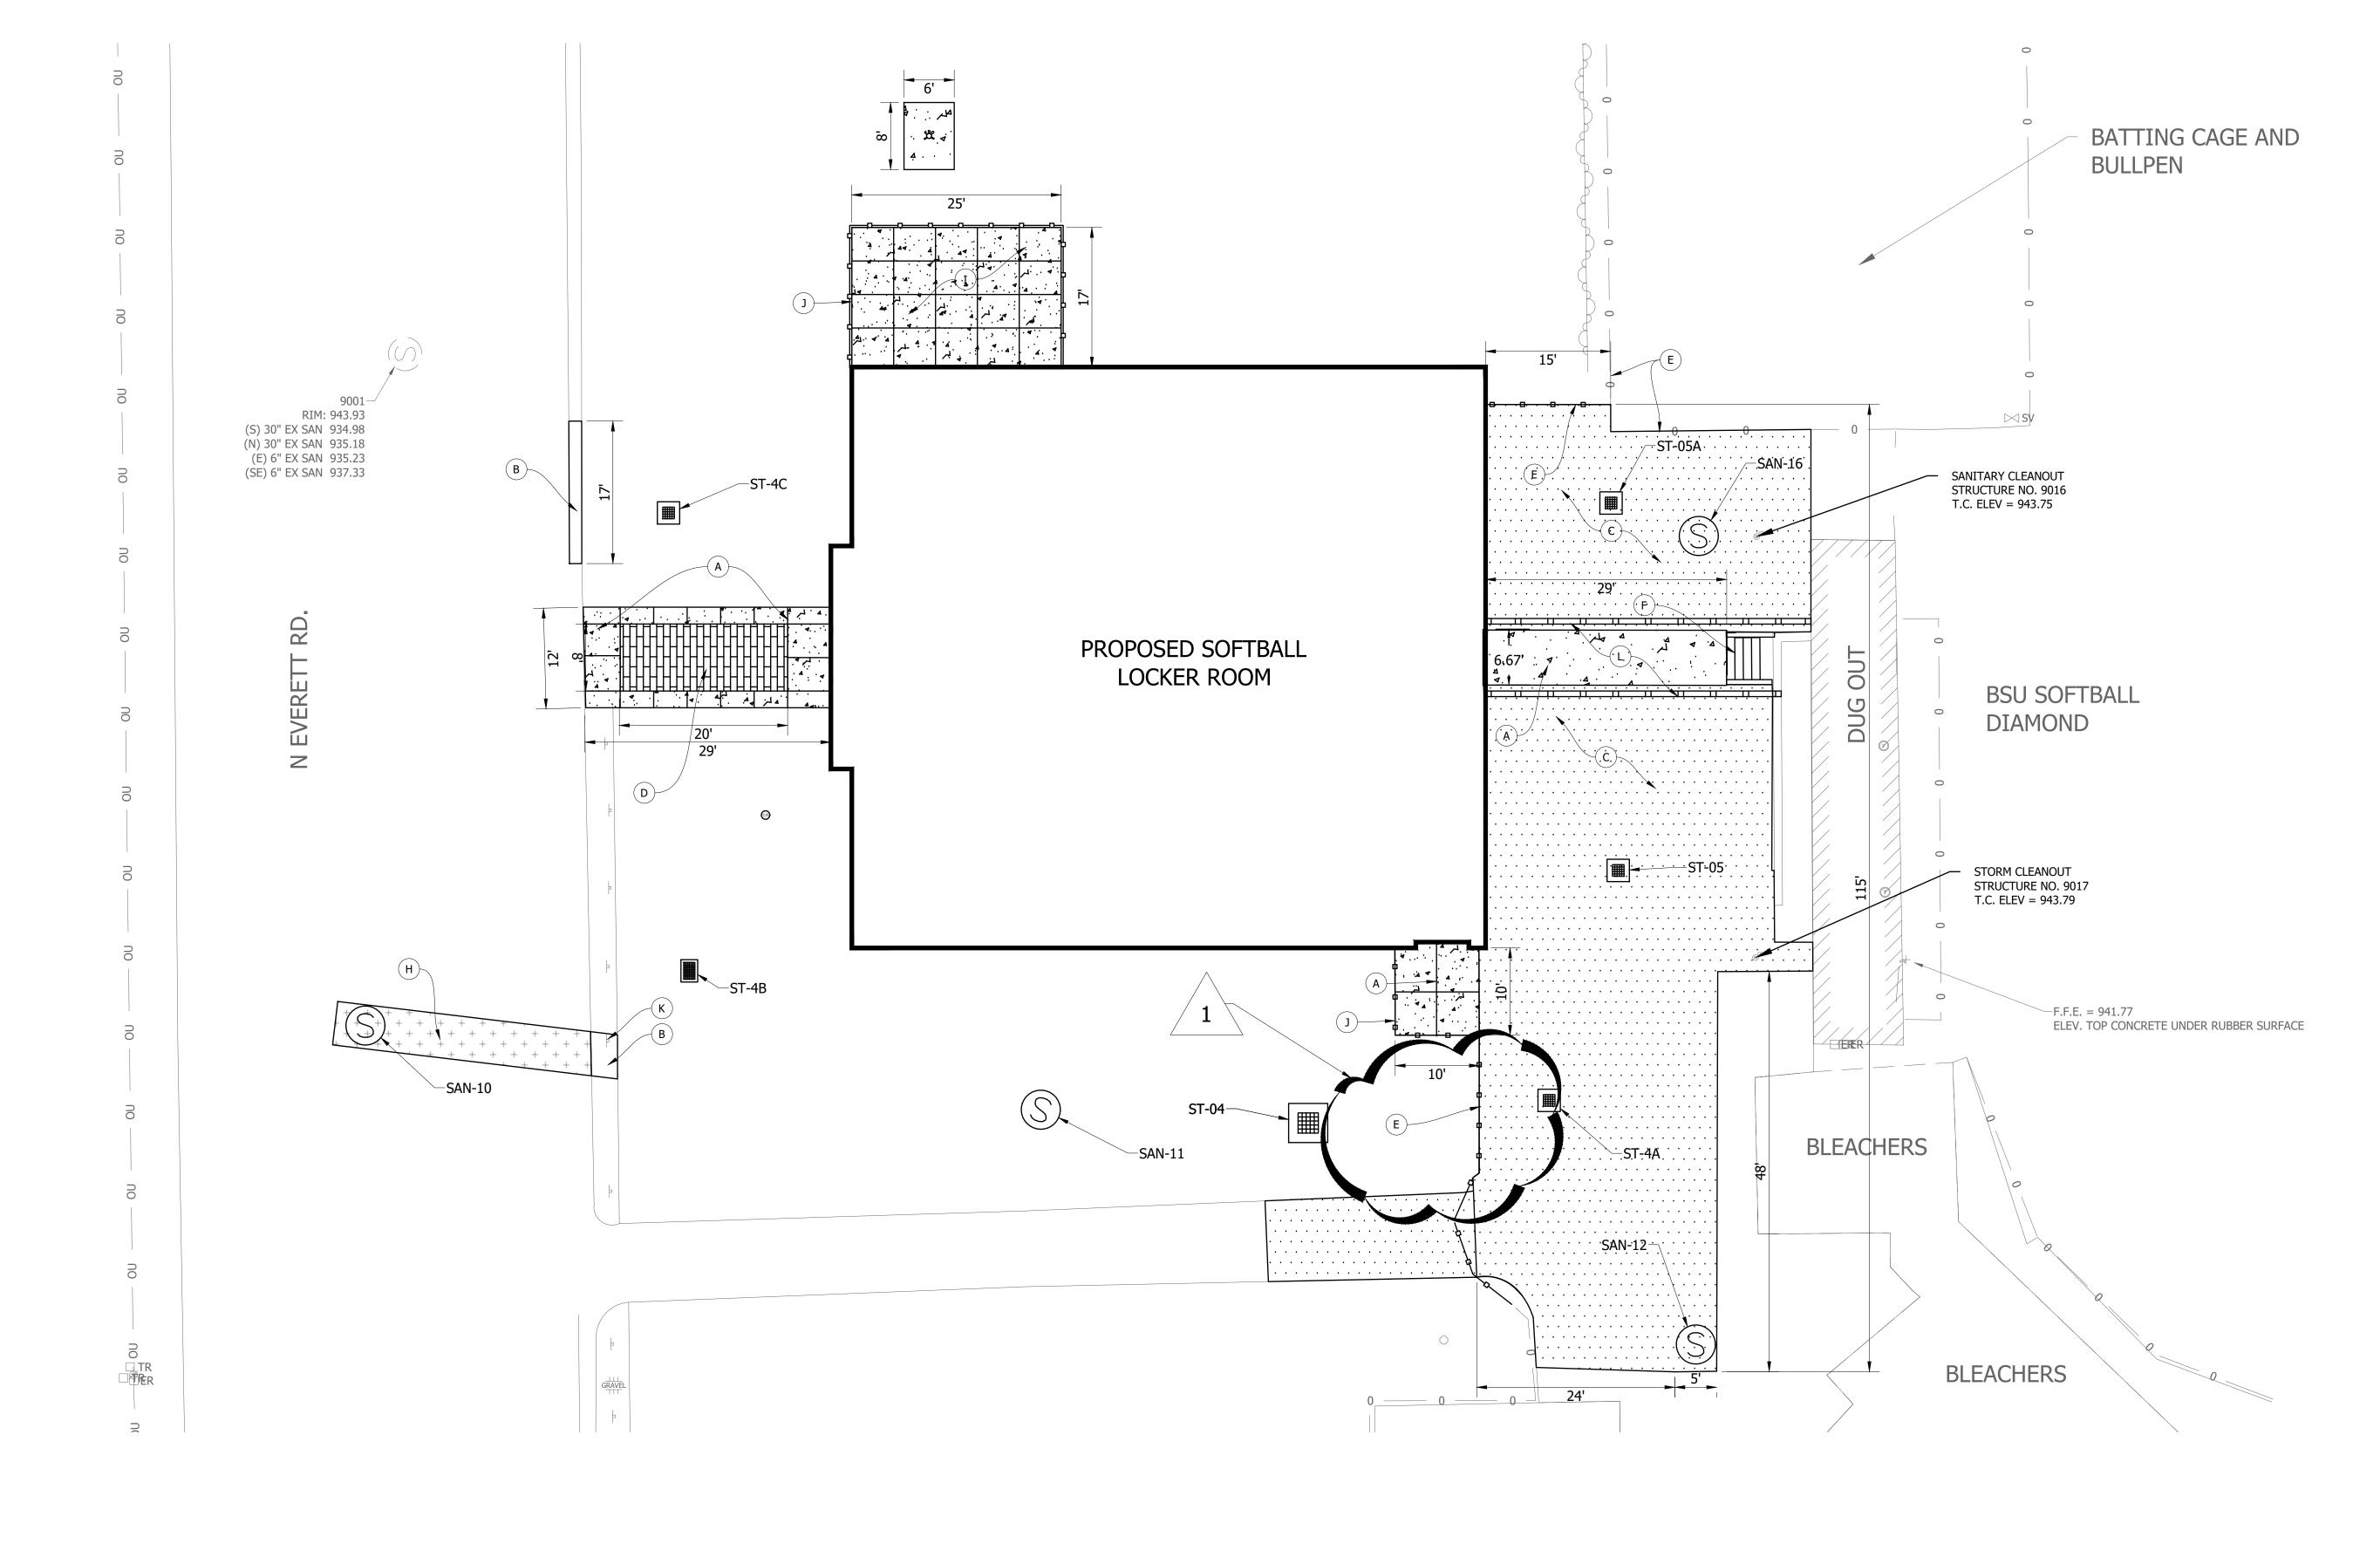
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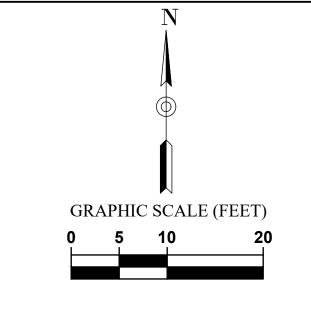
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PROJECT NO.

SITE PLAN -SOFTBALL





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## SITE WORK GENERAL NOTES AND SPECIFICATIONS

- 1. THE CONTRACTOR SHALL BE RESPONSIBLE FOR OBTAINING, OR VERIFYING, THAT ALL PERMITS AND APPROVALS ARE OBTAINED FROM THE RESPECTIVE CITY, COUNTY, STATE AND ANY OTHER REGULATORY AGENCIES PRIOR TO STARTING CONSTRUCTION.
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- 5. ALL QUANTITIES GIVEN ON THE PRINTS, VERBALLY OR IN THE SCOPE OF WORK SECTION ARE ESTIMATES AND SHALL BE CONFIRMED BY THE BIDDING CONTRACTOR.
- 6. OCCUPATIONAL SAFETY AND HEALTH ADMINISTRATION (OSHA) STANDARDS FOR EXCAVATIONS FINAL RULE 29 CFR PART 1926, SUBPART "P" APPLIES TO ALL EXCAVATIONS EXCEEDING
- EXCAVATIONS EXCEEDING TWENTY (20) FEET IN DEPTH REQUIRE THE DESIGN OF A TRENCH SAFETY SYSTEM BY A REGISTERED PROFESSIONAL ENGINEER.

## SITE PLAN NOTES

- 1. ALL RADII AND STREET DIMENSIONS SHALL BE MEASURED TO BACK OF CURB OR FACE OF INTEGRAL CURB AND WALK. ALL DIMENSIONS TO THE BUILDING ARE TO THE OUTSIDE OF BUILDING FOUNDATION WALL.
- 2. ALL PAVEMENT AND/OR CURB RADII TO BE FIVE (5) FOOT UNLESS OTHERWISE NOTED.
- 3. BEARINGS, DIMENSIONS AND EASEMENTS ARE SHOWN FOR REFERENCE ONLY. REFER TO RECORDED BOUNDARY SURVEYS, ALTAS AND SECONDARY PLATS FOR EXACT INFORMATION.
- 4. REFER TO ARCHITECTURAL PLANS FOR DETAILS OF BUILDINGS AND BUILDING DIMENSIONS. 5. TEMPORARY TRAFFIC CONTROL DURING CONSTRUCTION SHALL CONFORM TO APPLICABLE
- LOCAL STANDARDS. 6. REFER TO UTILITY PLAN FOR SANITARY AND STORM STRUCTURE LOCATIONS.
- 7. ANY DISCREPANCIES OR CONFLICTS WHICH BECOME APPARENT BEFORE OR DURING CONSTRUCTION SHALL BE BROUGHT TO THE ATTENTION OF THE ENGINEER OF RECORD IMMEDIATELY SO THAT CLARIFICATION OR REDESIGN MAY OCCUR.

## LEGEND

- A 4" CONCRETE SIDEWALK
- NEW STEPS TO DUGOUT. SEE STRUCTURAL DETAILS.
- BRICK SIDEWALK. SEE ARCHITECTURE DETAILS.
- NEW FENCING TO MATCH ADJACENT EXISTING FENCE
- F 6" CONCRETE PAD
  - NEW FENCING. SEE ARCHITECTURAL PLANS
- NEW 6" CONCRETE CURB
- RESET EXISTING PLANTER
- NEW COVERED WALKWAY. SEE ARCHITECTURE DETAILS.



PROPOSED CONCRETE PAVEMENT

PROPOSED ASPHALT WALK

## BUILDING LOCKER RO SOF BASEBALL

IN 47306

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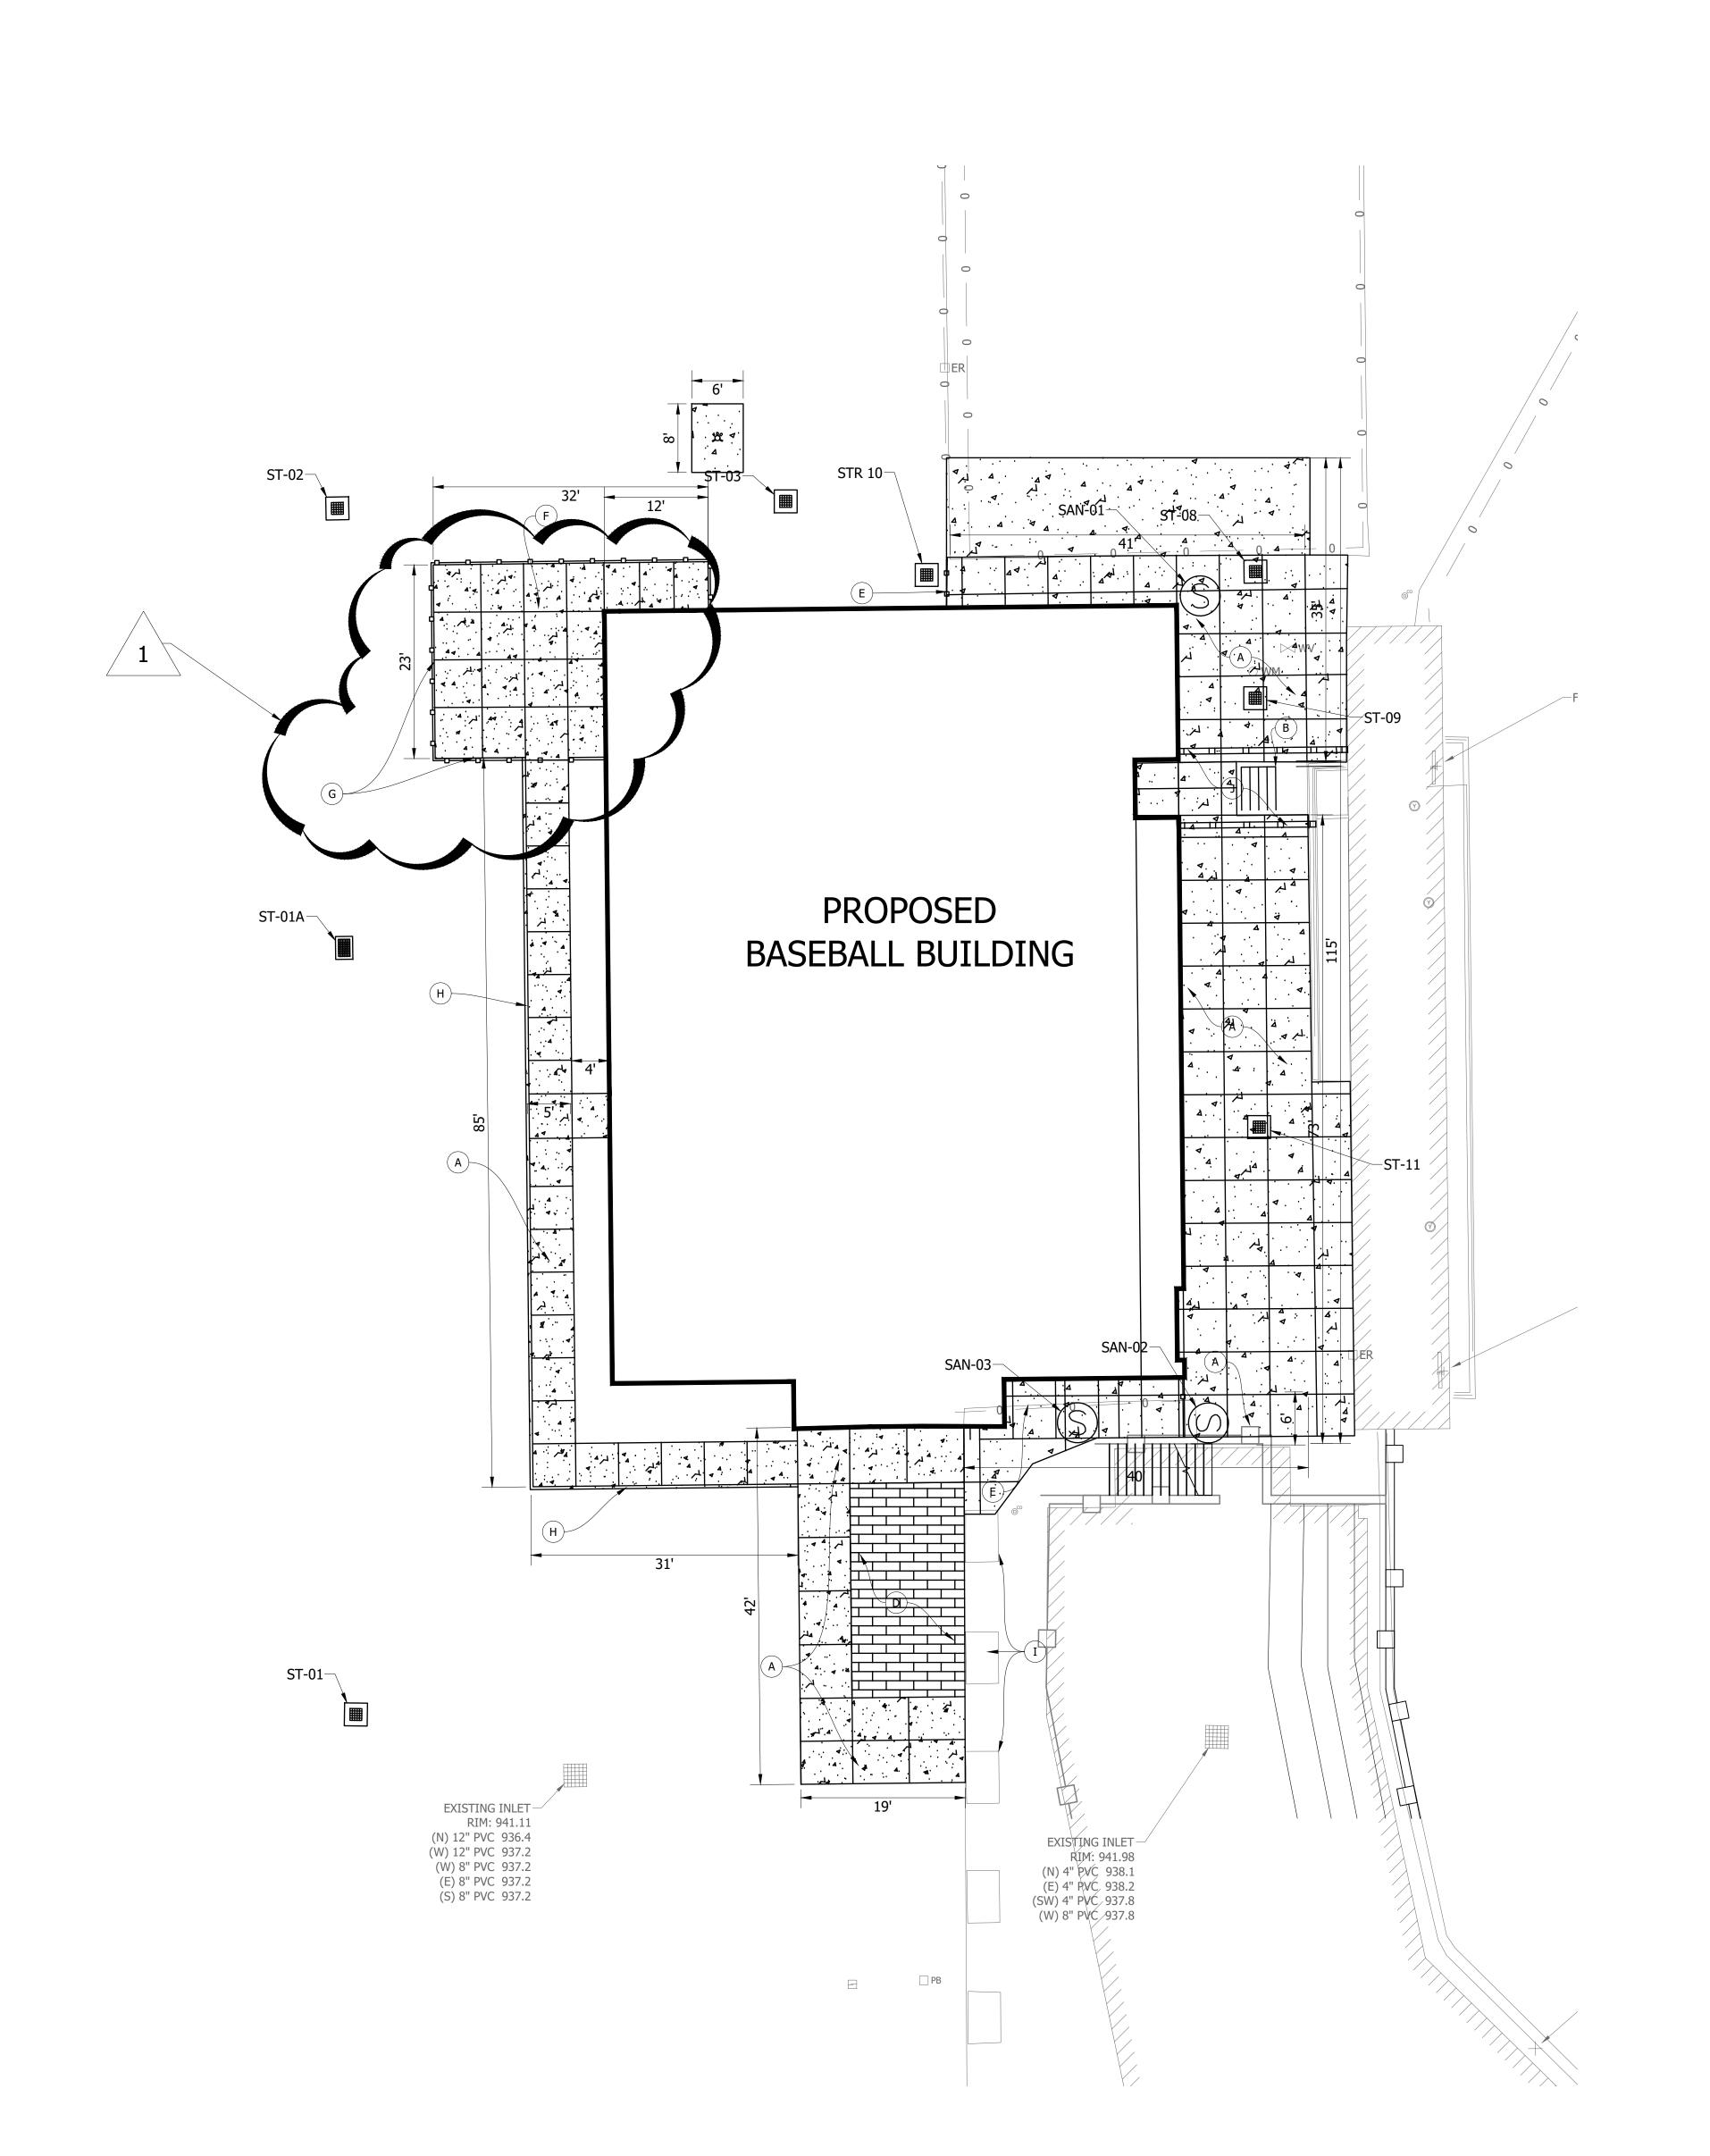
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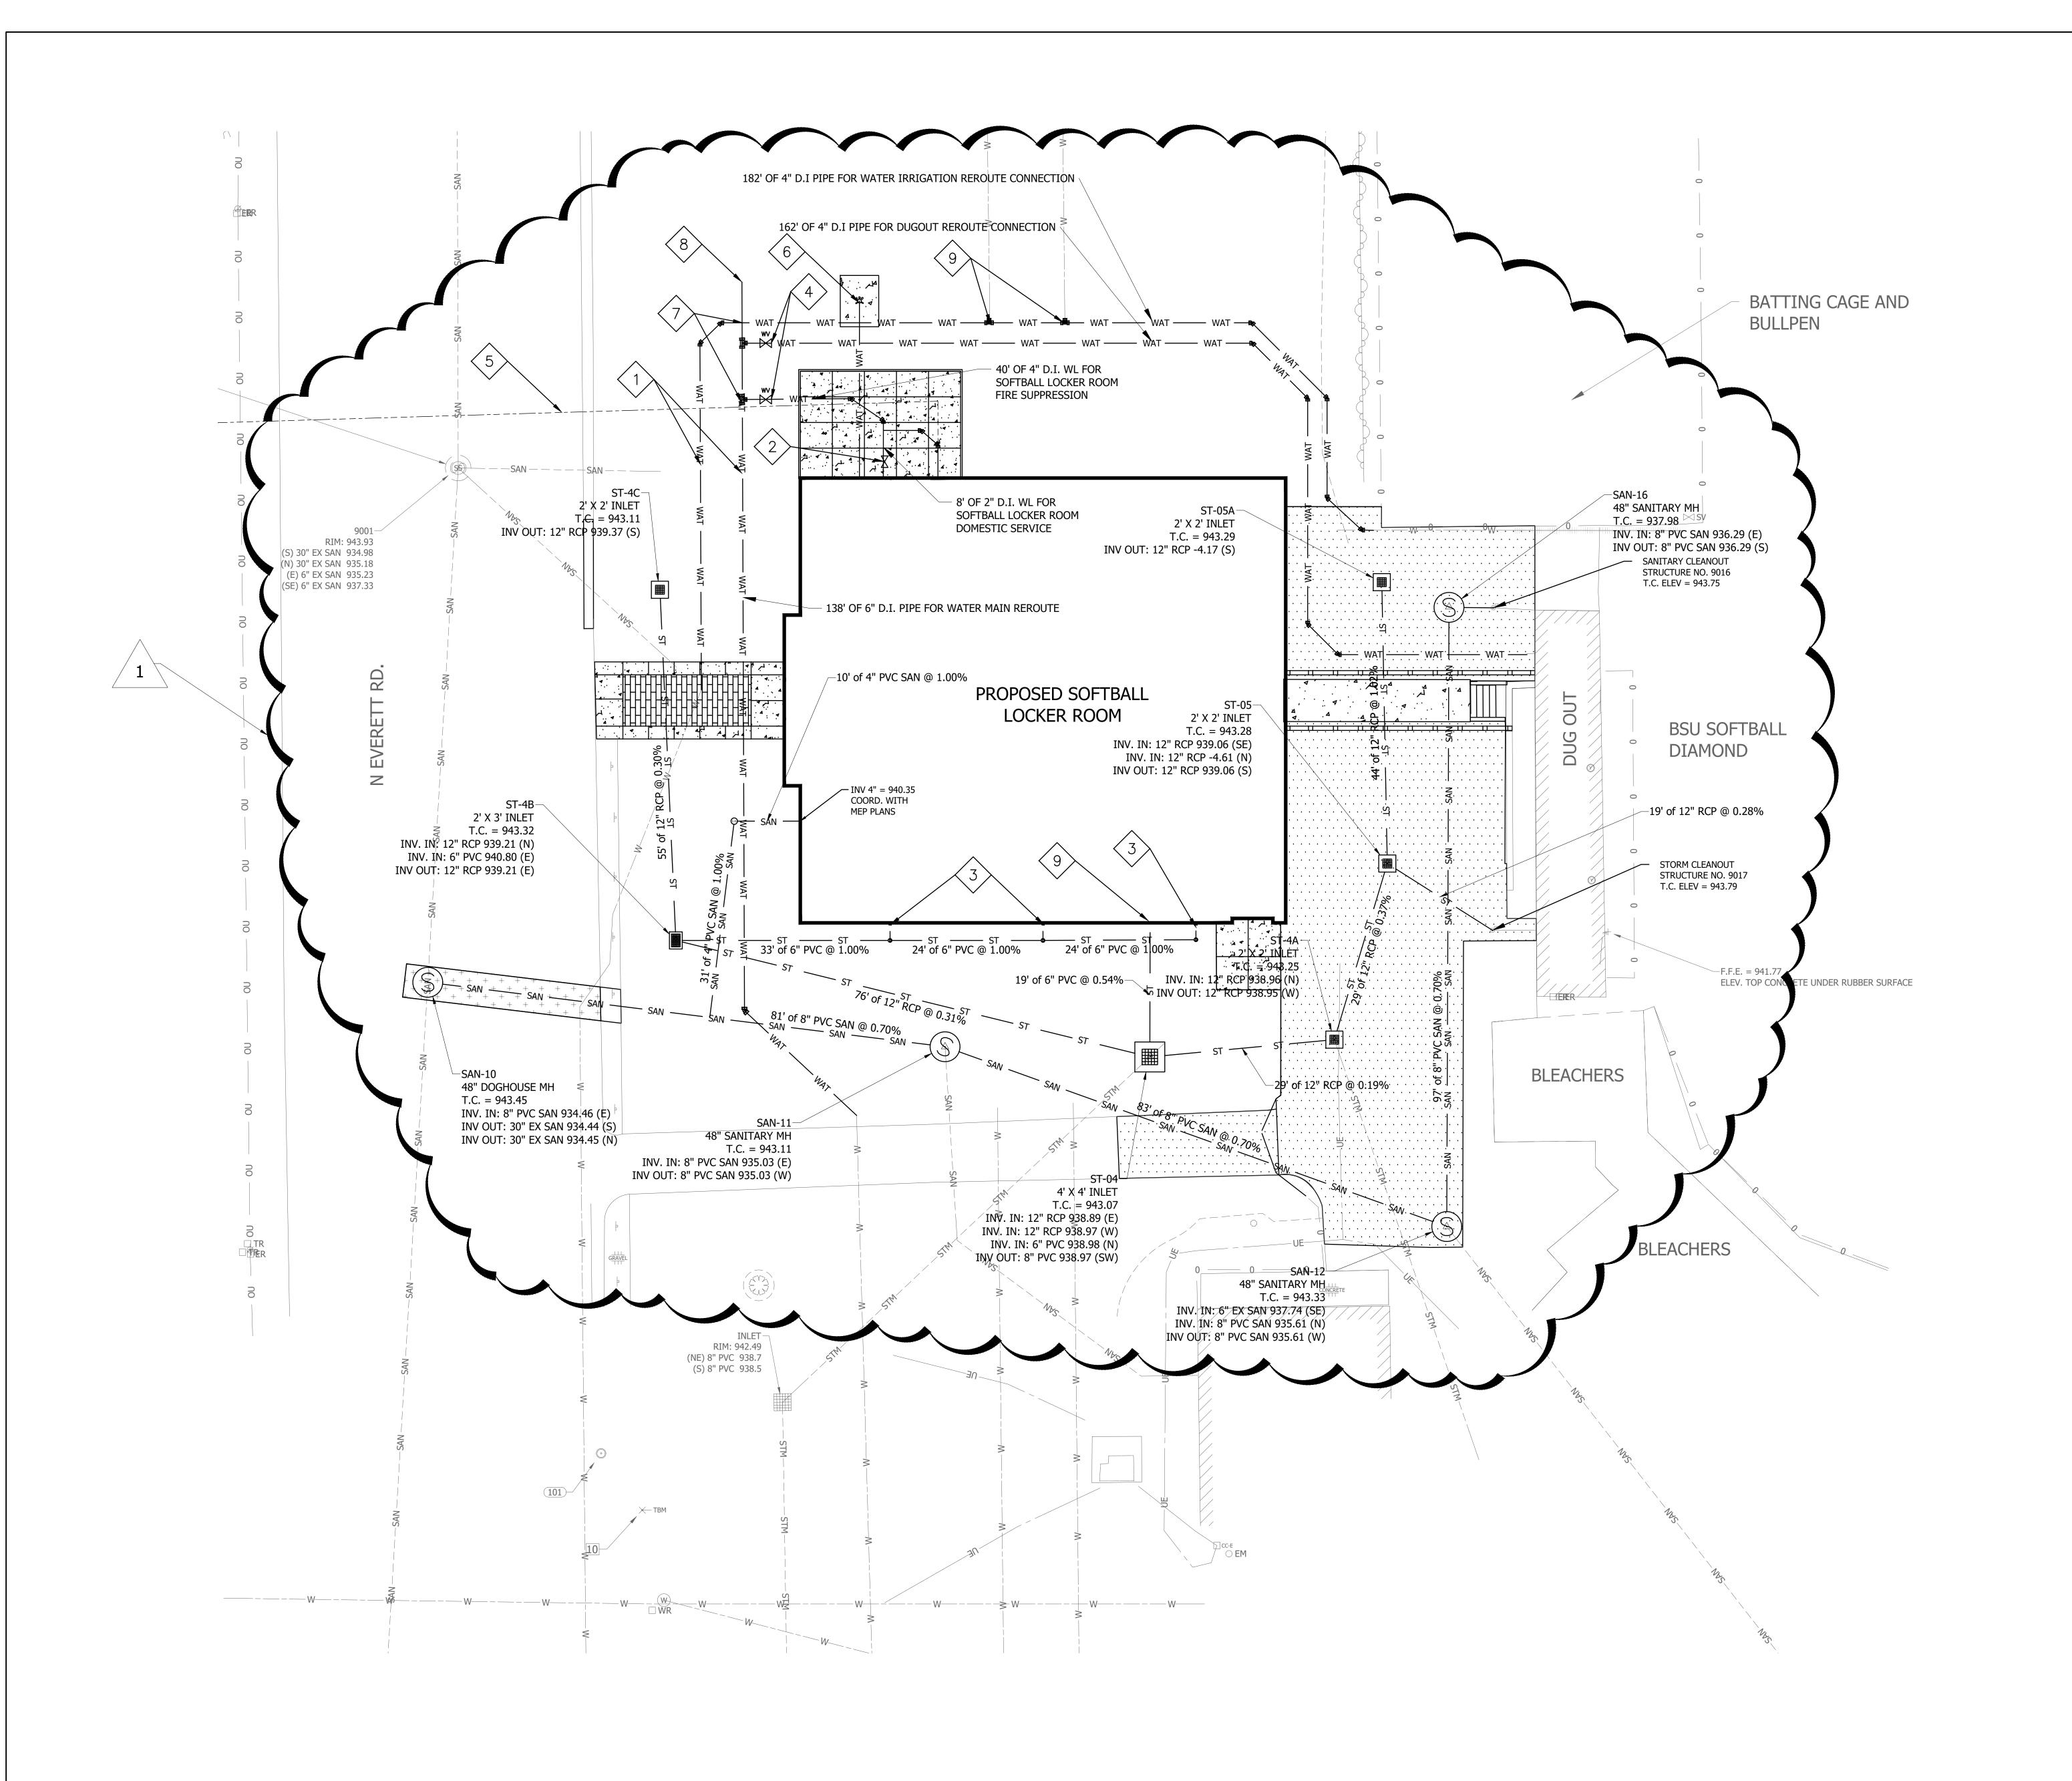
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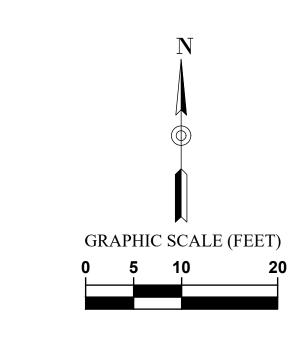
PROJECT NO.

SITE PLAN -BASEBALL

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## UTILITY PLAN LEGEND

0	stst -	——-sт —	st	STORM SEWER, MANHOLE
				SUBSURFACE DRAIN (SSD)
<b></b>		RD	RD	ROOF DRAIN, CLEANOUT
	<b>→</b>	- w		WATER LINE, METER, VALVE
	)ssss -	ss	ss	SANITARY SEWER, MANHOLE
<b>@</b>	ssss -	ss	ss	SANITARY LATERAL, CLEAN OUT
			- — —	EASEMENT LINE
<u>O</u> .	<u>Э —                                    </u>	Е	—Е——	OVERHEAD ELECTRIC, POLE
Ē	)—————————————————————————————————————	BEC -	BEC -	BURIED ELECTRIC, MANHOLE
			_	OVERHEAD CABLE TELEVISION
		-		BURIED CABLE TELEVISION
<b>(BM</b> )	)———— «-		c	GAS LINE, METER, VALVE
<del></del>	<del></del>	<del></del>	-	OVERHEAD TELEPHONE LINE
-				BURIED TELEPHONE LINE
	$\blacksquare$			END SECTION
				CURB INLET

STORM SEWER INLETS

THE TITING

TAPPING SLEEVE & VALVE

FIRE HYDRANT

FIRE DEPARTMENT CONNECTION

POST INDICATOR VALVE

STREET LIGHT

TRANSFORMER

ELECTRIC METER

CABLE RISER PEDESTAL

PROPOSED BRICK WALK

PROPOSED CONCRETE PAVEMENT

## PROPOSED ASPHALT WALK PROPOSED TRENCH PATCH

## UTILITY PLAN NOTES:

- SEE ARCHITECTURAL PLUMBING PLANS FOR PLUMBING DETAILS TO AREAS FIVE (5) FEET OUTSIDE AND INSIDE OF THE PROPOSED STRUCTURE.
- 2. SITE CONTRACTOR TO VERIFY ALL BUILDING LATERALS WITH PLUMBING DRAWINGS PRIOR TO CONSTRUCTION.
- 3. SITE UTILITY CONTRACTOR TO VERIFY BUILDING CONNECTION LOCATIONS AND ELEVATIONS WITH MEP AND ARCHITECTURAL PLANS PRIOR TO CONSTRUCTION.
- 4. EXISTING UTILITY LOCATIONS ARE APPROXIMATE. THE CONTRACTOR SHALL DETERMINE AND FIELD VERIFY ALL HORIZONTAL AND VERTICAL LOCATIONS PRIOR TO COMMENCEMENT OF
- CONSTRUCTION.

  5. RIM ELEVATION (RE) SHALL INDICATE THE ELEVATION THAT WATER WOULD ENTER THE
- GRATE FOR ALL CASTINGS. IF CASTING HAS SOLID LID, THE RE IS THE LID ELEVATION.

  WATER AND SEWER CROSSINGS AND SEPARATIONS SHALL BE IN ACCORDANCE WITH "TEN
- 6. WATER AND SEWER CROSSINGS AND SEPARATIONS SHALL BE IN ACCORDANCE WITH "TEN STATE STANDARDS" AND LOCAL CODES.
- 7. WATER LINES THROUGHOUT THE PROJECT SHALL BE INSTALLED WITH AT LEAST 54 INCHES OF COVER TO PROVIDE PROTECTION FROM FREEZING.
- 8. PLASTIC WATER LINES SHALL BEAR THE NSF SEAL OF APPROVAL AND MEET COMMERCIAL STANDARD NO. 256-3, PRODUCT STANDARD 22-70, OR ASTM D 2441.
- ALL SUB-SURFACE DRAIN (SSD) SHALL BE 6" PERFORATED DUAL WALL HDPE UNLESS NOTED OTHERWISE.
- 10. INVERT ELEVATION OF SUB-SURFACE DRAIN (SSD) AT STRUCTURE TO BE THREE (3) FEET BELOW RIM ELEVATION. ALL STORM STRUCTURES MUST HAVE AT LEAST 3 SUB SURFACE DRAIN CONNECTIONS.
- DRAIN CONNECTIONS.

  11. REFER TO CITY OF MUNCIE DETAIL SHEETS C914 & C919 FOR BACKFILL REQUIREMENTS
- FOR STORM & SANITARY SEWERS.

  12. REFER TO CITY OF MUNCIE SHEETS C919—C924 FOR TOWN OF FISHERS SANITARY SEWER

15. SEE STRUCTURE DATA TABLE DETAILS ON SHEETS C705 (STORM) & C801 (SANITARY).

- 13. REFER TO DETAIL SHEETS C914—C918 FOR CITY OF MUNCIE STORM SEWER DETAILS.
- 14. REFER TO SHEETS IN THE C900 SERIES FOR ALL OTHER CITY OF MUNCIE DETAILS.
- 16. CONNECTIONS TO EXISTING STRUCTURES REQUIRE THAT THE STRUCTURE BE REHABILITATED TO CURRENT DPW DESIGN STANDARDS.

17. ANY DISCREPANCIES OR CONFLICTS WHICH BECOME APPARENT BEFORE OR DURING

- CONSTRUCTION SHALL BE BROUGHT TO THE ATTENTION OF THE ENGINEER OF RECORD IMMEDIATELY SO THAT CLARIFICATION OR REDESIGN MAY OCCUR.
- 18. ALL EXISTING STRUCTURES, MANHOLES, AND CATCH BASIN GRATES SHALL BE ADJUSTED TO NEW FINISH GRADE ELEVATIONS.
- 19. ALL UTILITY STRUCTURES IN PAVED AREAS SHALL BE TRAFFIC BEARING AND SHALL BE FLUSH WITH ADJACENT PAVEMENT.

## KEYNOTE LEGEND

- 1) CONNECT WATER TO EXISTING WITH STAINLESS STEEL TAPPING SLEEVE AND VALVE.
- POST INDICATOR VALVE SEE FIRE PROTECTION PLANS AND ELECTRICAL PLANS FOR LOW VOLTAGE WIRING.
- DOWN SPOUT WITH BOOT FOR UNDERGROUND DRAINAGE TO FOOTING DRAIN SEE STRUCTURAL PLANS
- PLANS

  4 NEW WATER VALVE
- 5 NEW ELECTRIC WIRE SEE ELECTRICAL PLANS
- 6 NEW FIRE DEPARTMENT CONNECTION
- 7 6" GATE VALVE WITH MECHANICAL JOINTS
- 8 6" END CAP
- 9 4" GATE VALVE WITH MECHANICAL JOINTS

# BALL & SOFTBALL LOCKER ROOM BUILDING

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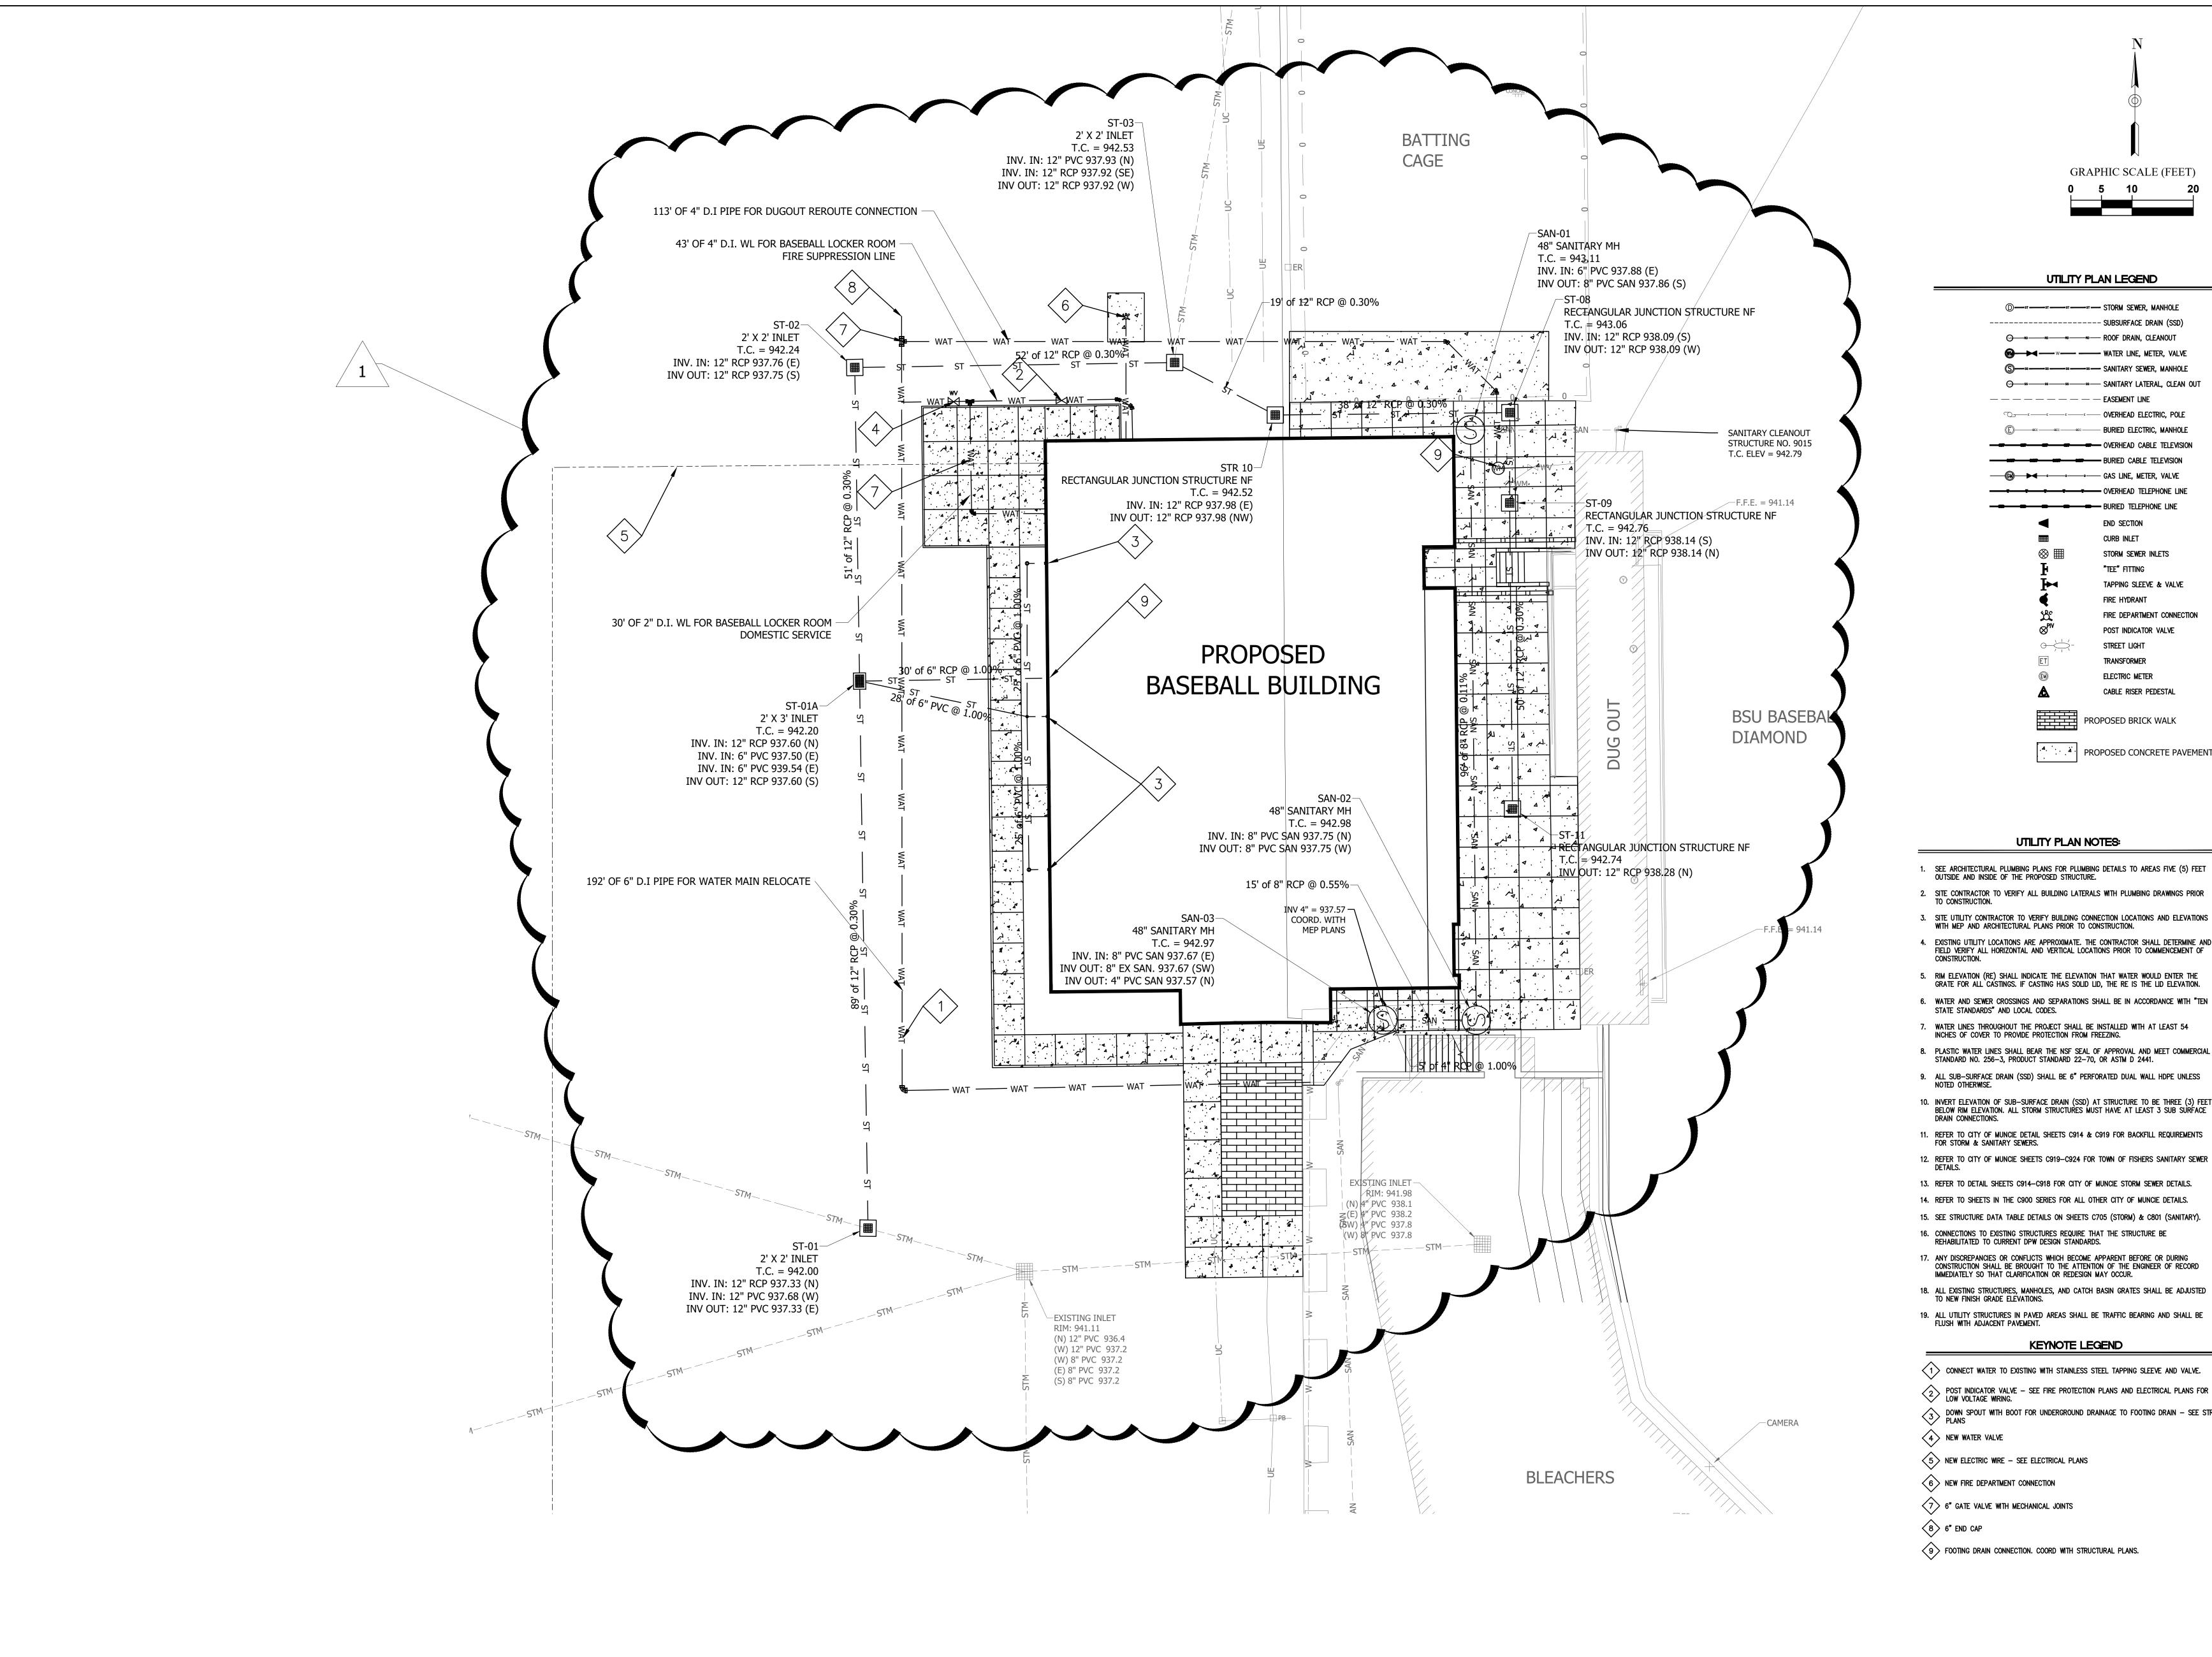
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PROJECT NO.

DRAWING TITLE:

SOFTBALL

UTILITY PLAN -





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## UTILITY PLAN LEGEND

GRAPHIC SCALE (FEET)

	→st — STORM SEWER, MANHOLE
	SUBSURFACE DRAIN (SSD)
©	-∞- ROOF DRAIN, CLEANOUT
<b>⋒</b> ────	WATER LINE, METER, VALVE
⑤—s—s——s—	→s — SANITARY SEWER, MANHOLE
	—ss—— SANITARY LATERAL, CLEAN OUT
	— — EASEMENT LINE
EE	-E OVERHEAD ELECTRIC, POLE
<b>€</b> — ■ ■ ■ ■ ■ ■ ■ ■ ■ ■ ■ ■ ■ ■ ■ ■ ■ ■	BURIED ELECTRIC, MANHOLE
<del></del>	OVERHEAD CABLE TELEVISION
	BURIED CABLE TELEVISION
<b>──®</b> ─ <b>►</b> <	-∘ GAS LINE, METER, VALVE
<del></del>	OVERHEAD TELEPHONE LINE
<del></del>	BURIED TELEPHONE LINE
◀	END SECTION
	CURB INLET
⊗ ⊞	STORM SEWER INLETS
ŀ	"TEE" FITTING
<b>ŀ</b> ⊶	TAPPING SLEEVE & VALVE
◀	FIRE HYDRANT
<b>%</b>	FIRE DEPARTMENT CONNECTION
$\otimes^{PIV}$	POST INDICATOR VALVE
O-\\\\\\\\\\\\\\\\\\\\\\\\\\\\\\\\\\\\	STREET LIGHT
ET	TRANSFORMER
(EM)	ELECTRIC METER
A	CABLE RISER PEDESTAL
	PROPOSED BRICK WALK
.A. A.	PROPOSED CONCRETE PAVEMEN

## UTILITY PLAN NOTES:

- SEE ARCHITECTURAL PLUMBING PLANS FOR PLUMBING DETAILS TO AREAS FIVE (5) FEET OUTSIDE AND INSIDE OF THE PROPOSED STRUCTURE.
- 2. SITE CONTRACTOR TO VERIFY ALL BUILDING LATERALS WITH PLUMBING DRAWINGS PRIOR
- WITH MEP AND ARCHITECTURAL PLANS PRIOR TO CONSTRUCTION. 4. EXISTING UTILITY LOCATIONS ARE APPROXIMATE. THE CONTRACTOR SHALL DETERMINE AND FIELD VERIFY ALL HORIZONTAL AND VERTICAL LOCATIONS PRIOR TO COMMENCEMENT OF
- 5. RIM ELEVATION (RE) SHALL INDICATE THE ELEVATION THAT WATER WOULD ENTER THE GRATE FOR ALL CASTINGS. IF CASTING HAS SOLID LID, THE RE IS THE LID ELEVATION.
- 6. WATER AND SEWER CROSSINGS AND SEPARATIONS SHALL BE IN ACCORDANCE WITH "TEN
- 7. WATER LINES THROUGHOUT THE PROJECT SHALL BE INSTALLED WITH AT LEAST 54
- INCHES OF COVER TO PROVIDE PROTECTION FROM FREEZING.
- 8. PLASTIC WATER LINES SHALL BEAR THE NSF SEAL OF APPROVAL AND MEET COMMERCIAL STANDARD NO. 256-3, PRODUCT STANDARD 22-70, OR ASTM D 2441.
- 9. ALL SUB-SURFACE DRAIN (SSD) SHALL BE 6" PERFORATED DUAL WALL HDPE UNLESS NOTED OTHERWISE.
- 10. INVERT ELEVATION OF SUB-SURFACE DRAIN (SSD) AT STRUCTURE TO BE THREE (3) FEET BELOW RIM ELEVATION. ALL STORM STRUCTURES MUST HAVE AT LEAST 3 SUB SURFACE
- 11. REFER TO CITY OF MUNCIE DETAIL SHEETS C914 & C919 FOR BACKFILL REQUIREMENTS FOR STORM & SANITARY SEWERS.
- 12. REFER TO CITY OF MUNCIE SHEETS C919-C924 FOR TOWN OF FISHERS SANITARY SEWER
- 13. REFER TO DETAIL SHEETS C914—C918 FOR CITY OF MUNCIE STORM SEWER DETAILS.
- 14. REFER TO SHEETS IN THE C900 SERIES FOR ALL OTHER CITY OF MUNCIE DETAILS. 15. SEE STRUCTURE DATA TABLE DETAILS ON SHEETS C705 (STORM) & C801 (SANITARY).
- 16. CONNECTIONS TO EXISTING STRUCTURES REQUIRE THAT THE STRUCTURE BE REHABILITATED TO CURRENT DPW DESIGN STANDARDS.
- 17. ANY DISCREPANCIES OR CONFLICTS WHICH BECOME APPARENT BEFORE OR DURING CONSTRUCTION SHALL BE BROUGHT TO THE ATTENTION OF THE ENGINEER OF RECORD
- 18. ALL EXISTING STRUCTURES, MANHOLES, AND CATCH BASIN GRATES SHALL BE ADJUSTED TO NEW FINISH GRADE ELEVATIONS.
- 19. ALL UTILITY STRUCTURES IN PAVED AREAS SHALL BE TRAFFIC BEARING AND SHALL BE FLUSH WITH ADJACENT PAVEMENT.

## KEYNOTE LEGEND

- CONNECT WATER TO EXISTING WITH STAINLESS STEEL TAPPING SLEEVE AND VALVE.
- POST INDICATOR VALVE SEE FIRE PROTECTION PLANS AND ELECTRICAL PLANS FOR LOW VOLTAGE WIRING. DOWN SPOUT WITH BOOT FOR UNDERGROUND DRAINAGE TO FOOTING DRAIN - SEE STRUCTURAL PLANS
- (5) NEW ELECTRIC WIRE SEE ELECTRICAL PLANS

- 9 FOOTING DRAIN CONNECTION. COORD WITH STRUCTURAL PLANS.

PROJECT NO. DRAWING TITLE: UTILITY PLAN -

BASEBALL

C4.02B

**GENERAL NOTES - SITE** 

1. ARCHITECTURAL SITE PLAN FOR REFERENCE. REFER TO CIVIL DRAWINGS.

## **KEYNOTES - SITE**

- 4.01 EXISTING TREE IS TO BE RELOCATED BY BSU. CONTRACTOR TO COORDINATE WITH US. 4.02 EXISTING SIGNS IN THE PARKING AREA ARE TO BE REALIGNED AND STRAIGHTENED OUT. REFER THE SIGNS NEXT TO THE CARS.
- 4.03 WALKWAY NEEDS TO STAY ACCESSIBLE AT ALL TIMES DURING THE SEASON.

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BUILDING

LOCKER SOF This drawing and the design concepts represented, as instruments

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PROJECT NO. DRAWING TITLE:

REFERENCE SITE PLAN


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## RR & SHOWERS


## **ENLARGED PLAN - PLAYERS RESTROOM & SHOWER**

13'-6" +/-

1'-2" 3'-0"

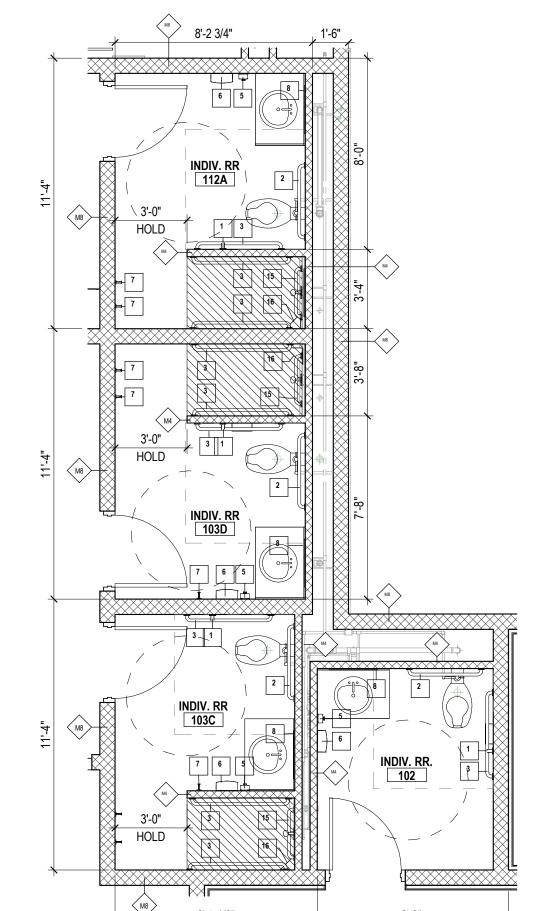

ENLARGED PLAN - COACHES + UMPIRE RESTROOM & SHOWER

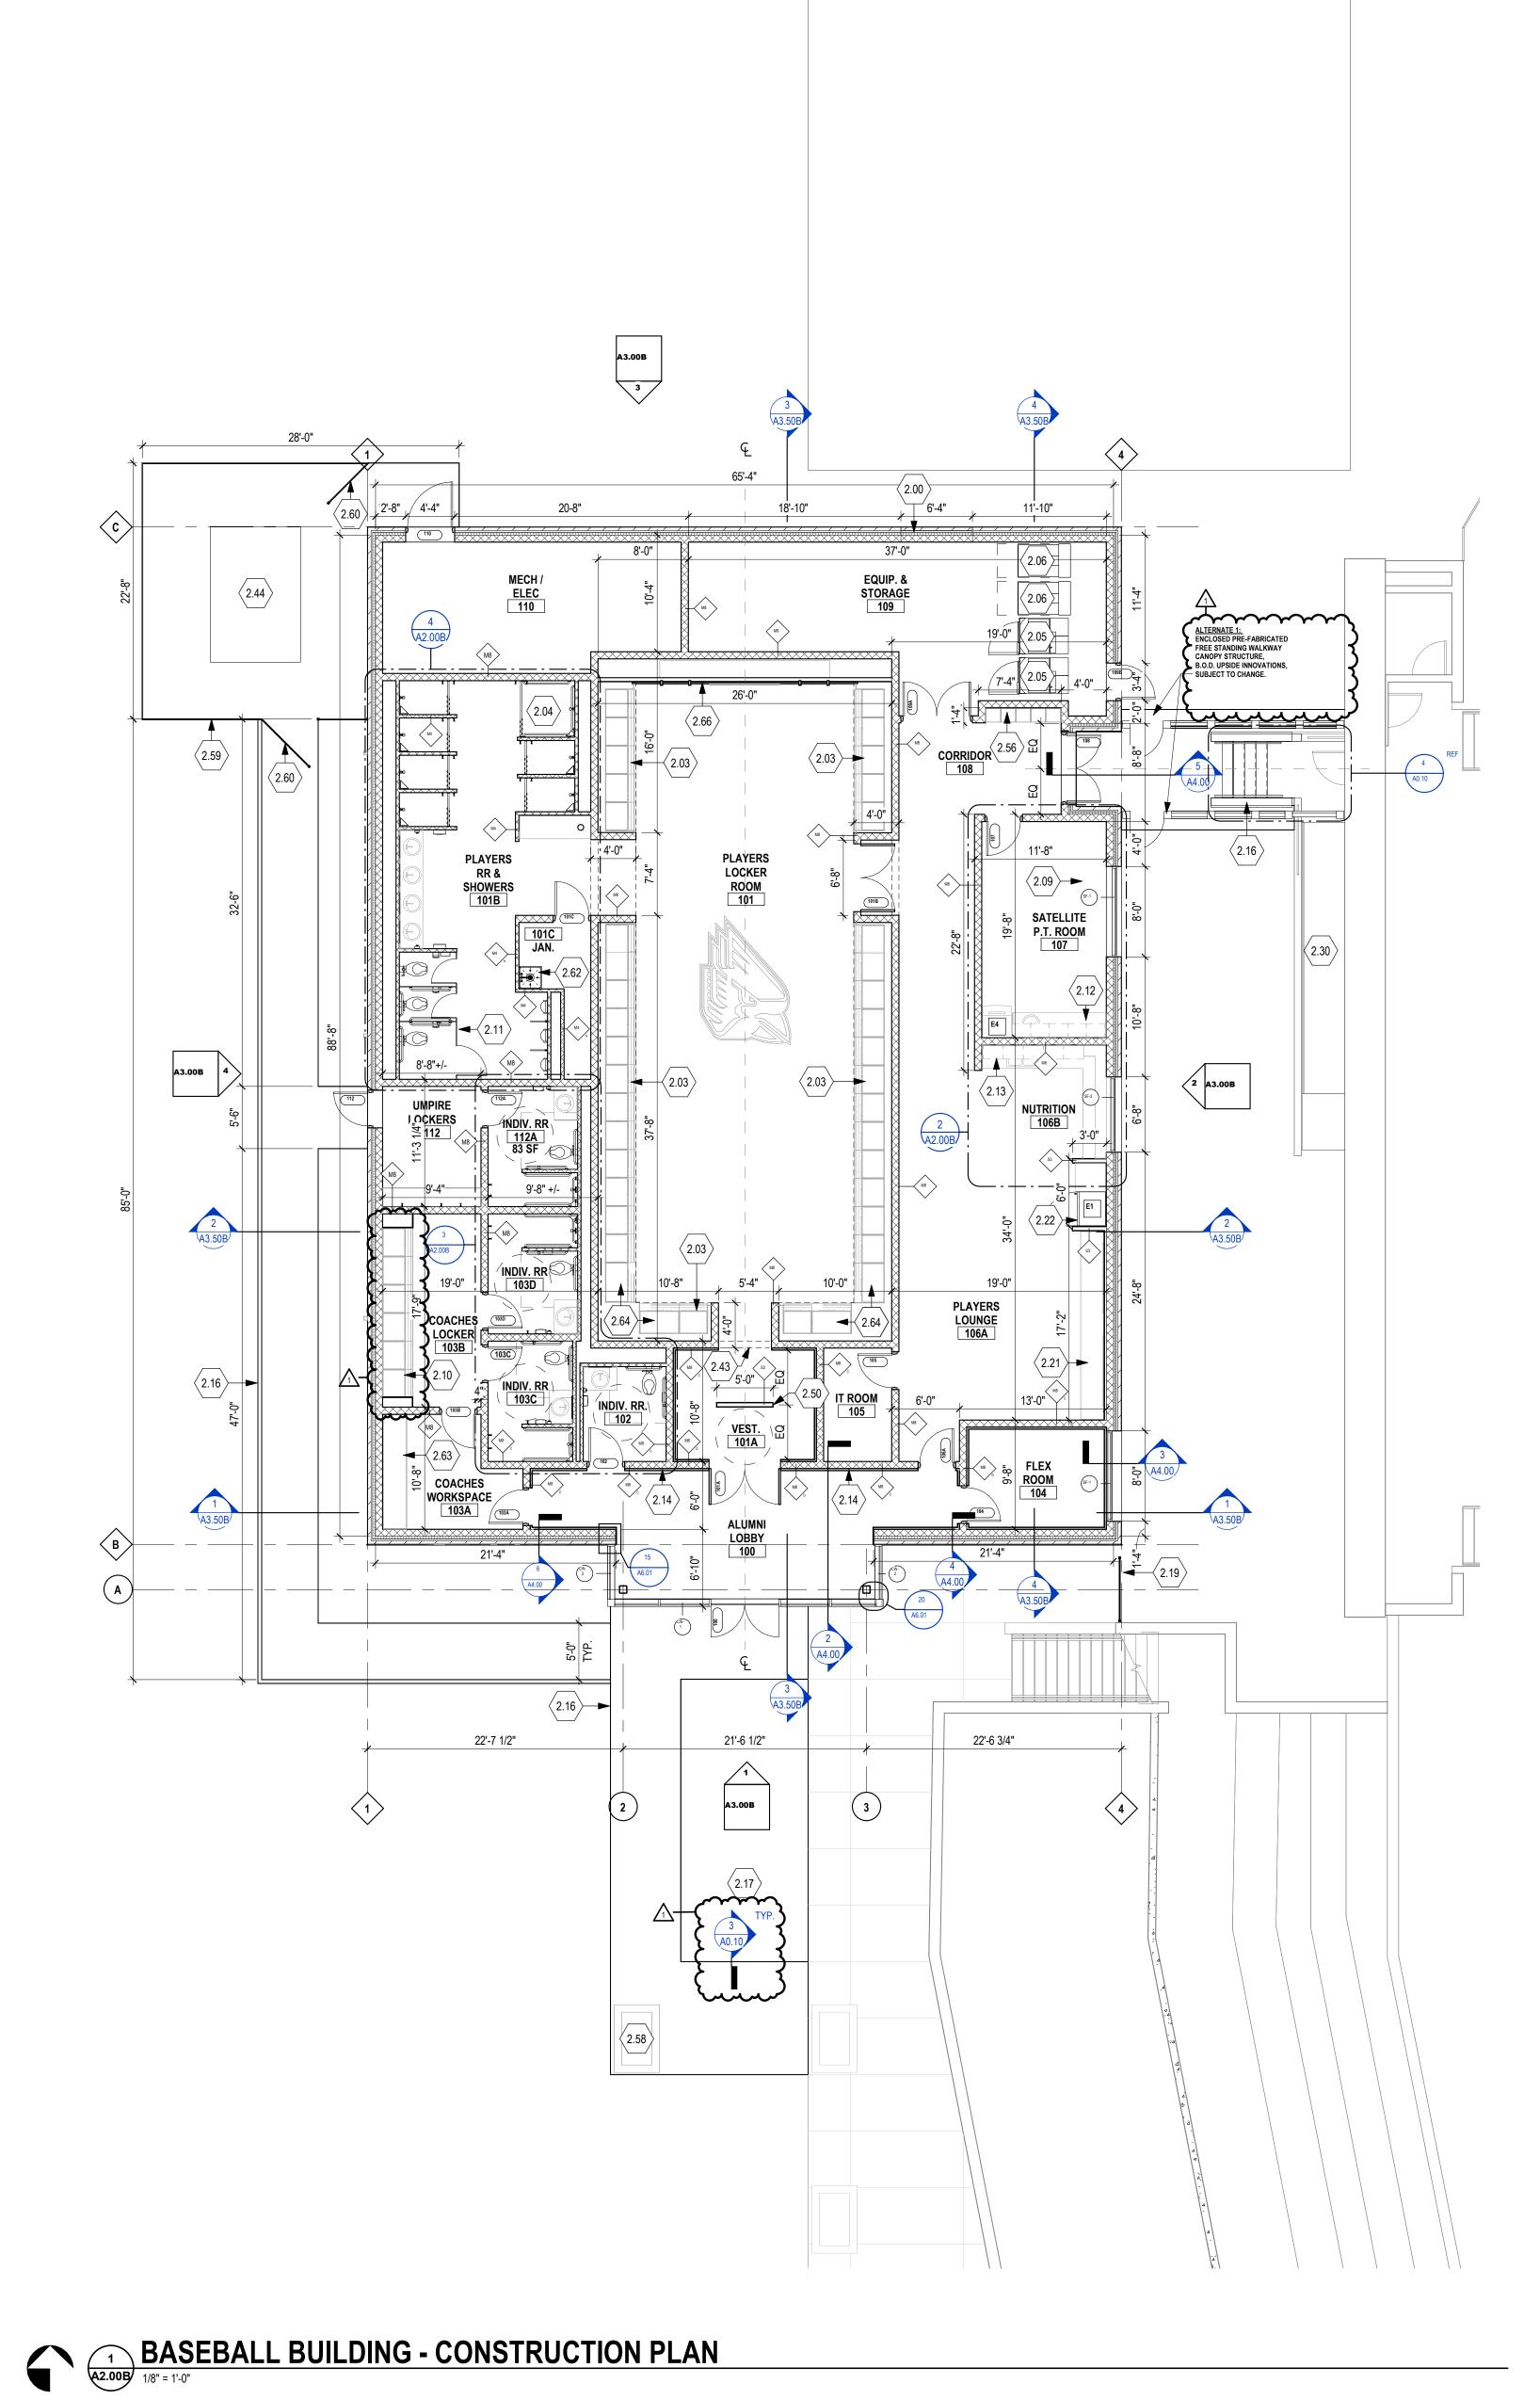

## **GENERAL CONSTRUCTION NOTES**

- A. ALL DIMENSIONS THAT ARE +/- OR ± (PLUS OR MINUS) ARE TO BE DETERMINED EXACTLY BY FIELD MEASUREMENT. B. ALL DIMENSIONS AND EXISTING CONDITIONS SHALL BE VERIFIED IN THE FIELD BEFORE PROCEEDING WITH THE WORK. ARCHITECT SHALL BE NOTIFIED OF ANY DISCREPANCIES.
- ALL DIMENSIONS HAVE PREFERENCE OVER SCALE, DO NOT SCALE DRAWINGS.
- LARGE SCALE DETAILS, GOVERN OVER SMALL SCALE DETAILS.
- IF CONTRACTOR SHOULD DISCOVER ANY UNFORSEEN PROBLEMS DURING THE REMOVAL OF ANY EXISTING CONSTRUCTION OR THE CONSTRUCTION OF ANY NEW WORK, THE ARCHITECT SHOULD BE NOTIFIED IMMEDIATELY AND THAT PARTICULAR WORK SHOULD BE DISCONTINUED UNTIL
- NECESSARY REVISIONS CAN BE DECIDED UPON. ALL DOORS IN METAL STUD PARTITIONS TO BE LOCATED WITH OUTSIDE EDGE OF THE FRAME 4" FROM PERPENDICULAR WALL. ALL MASONRY OPENINGS CREATED FOR NEW DOORS TO BE LOCATED 8" FROM PERPENDICULAR WALL. TYPICAL UNLESS NOTED OTHERWISE.
- G. ALL INTERIOR WALLS GO TO ROOF DECK, UNLESS NOTED OTHERWISE. H. WHEN INFILLING AN OPENING WITHIN A MASONRY WALL, TOOTH-IN MASONRY TO MATCH EXISTING COURSING, UNLESS NOTED OTHERWISE.
- I. ALL INTERIOR DIMENSIONS ARE TO FACE OF SHEATHING AND/OR FACE OF INTERIOR MASONRY, UNLESS NOTED OTHERWISE. COORDINATE FINAL PARITION LOCATIONS WITH FURRING AT STRUCTURAL ELEMENTS.
- K. COORDINATE INTERIOR CONCRETE SLAB ON GRADE CONTROL JOINT PATTERN AT ALL HARD-TILED SURFACE AREAS WITH ARCHITECT. ALL EXTERIOR DIMENSIONS ARE TO FACE OF FOUNDATION, FACE OF EXTERIOR SHEATHING, AND/OR FACE OF EXTERIOR MASONRY.
- M. PROVIDE 1/2" RADIUS BULLNOSE CMU UNITS AT ALL EXPOSED OUTSIDE CORNERS, TYPICAL UNLESS NOTED OTHERWISE. N. PAINT ALL EXPOSED EXTERIOR LINTELS TO MATCH THE BRICK MASONRY.

## **KEYNOTES - CONSTRUCTION**

- 2.00 KNOCKOUT WALL PANEL. LINTEL FOR A DOUBLE DOOR OPENING. PROVIDE CONTINOUS MASONRY JOINT.
- 2.03 96" H x 30" W x 30" D PHENOLIC ATHLETIC LOCKER WITH INTEGRATED POWER AT LOCKABLE COMPARTMENT & OPERABLE BENCH SEAT AT BASE, SEE MILLWORK DETAILS. MINIMUM 5% OF LOCKERS MUST BE ACCESSIBLE. TYPICAL AT ALL LOCATIONS UNLESS OTHERWISE NOTED. 2.04 AREA SHOWN HATCHED DEPICTS DEPRESSED SLAB AREA FOR SLOPED NO THRESHOLD EPOXY FLOOR SHOWER PAN. FLOOR DRAIN INSTALLED AT
- 1/2-INCH BELOW FINISHED FLOOR ELEVATION. SLOPE INFILL AND EPOXY TO LINEAR DRAIN, MINIMUM 1/4" / 1'-0". REFER TO PLUMBING & 2.05 APPROX. LOCATION OF FUTURE INDUSTRIAL GRADE WASHER UNITS, BY OWNER. CONTRACTOR TO PROVIDE ALL ROUGH-INS & CONCRETE
- EQUIPMENT PAD, AS NEEDED. REFER TO ELECTRICAL & PLUMBING DRAWINGS FOR FULL EXTENT OF WORK. 2.06 APPROX, LOCATION OF FUTURE INDUSTRIAL GRADE DRYER UNITS, BY OWNER, CONTRACTOR TO PROVIDE ALL ROUGH-INS & CONCRETE
- EQUIPMENT PAD, AS NEEDED. REFER TO ELECTRICAL & PLUMBING DRAWINGS FOR FULL EXTENT OF WORK.

- BE ACCESSIBLE PER 1109.12.1 OF THE INDIANA BUILDING CODE.

  2.11 TOILET/DRINALS WITH PARTITIONS. PROVIDE GRAB BARS AS REQUIRED BY ADA. REFER TO ACCESSORY SCHEDULE.
- 2.13 QUARTZ COUNTERTOP OVER BASE CABINETS WITH UNDERMOUNT SINK AND KITCHEN APPLIANCES. TBD BY OWNER. 2.14 LOCATION OF WALL-MOUNTED TV BY OWNER @ 5'-0" AFF ON CENTER U.O.N. PROVIDE IN-WALL CLOCKING AND POWER/DATA. REFER TO
- ELECTRICAL DRAWINGS. 2.15 SOLID SURFACE COUNTERTOP WITH UNDERMOUNT SINKS & WALL MOUNTED ACCESSORIES.


2.08 SOLID SURFACE MILLWORK WITH UNDERMOUNT SINK. REFER TO MILLWORK DETAILS.

2.12 QUARTZ COUNTERTOP OVER BASE CABINETS WITH WALL MOUNTED SHELVING ABOVE.

- 2.16 CONCRETE CURB AND WALKWAY, PREPARE FOR LANDSCAPING BY OWNER, REFER TO CIVIL DRAWINGS.
- 2.17 NEW BELDEN ADMIRAL RED BRICK PAVERS. SQUARE EDGES 2 1/4" X 4" X 8".
- 2.19 NEW DECORATIVE FENCING AND GATE WHEN APPLICABLE, TO MATCH EXISTING FENCING (6' HIGH TYP).
- 2.21 BASE CABINETS AND LOCATION FOR TVS. PROVIDE POWER FOR TVS. REFER TO INTERIOR ELEVATIONS.
- 2.22 REFRIGERATOR.
- 2.30 EXISTING DUGOUT AND ACCESS RAMP TO REMAIN. PROTECT DURING CONSTRUCTION. 2.43 LINTEL. REFER TO STRUCTURAL DRAWINGS.
- 2.44 CONCRETE PAD FOR MECHINICAL UNIT. REFER TO MECHANICAL DRAWINGS.
- 2.50 STANDALONE DIVIDER WALL. PROVIDE EXTRA WOOD BLOCKING
- 2.56 BUILT-IN SHOE STORAGE CUBBIES FOR A MINIMUM OF 40 PAIRS. PROVIDED BY OWNERS. 2.58 EXISTING CONCRETE PLANTER, PROTECT DURING CONSTRUCTION AND RELOCATE.
- 2.59 8' H BLACK VINYL-COATED CHAIN LINK FENCE WITH PRIVACY SCREENING. REFER TO SPECS.
- 2.60 8' H BLACK VINYL-COATED CHAIN LINK FENCE GATE WITH PRIVACY SCREENING. REFER TO SPECS. 2.62 MOP SINK. REFER TO PLUMBING DRAWINGS.
- 2.63 BUILT IN SOLID SERVICE WORK COUNTER. REFER TO INTERIOR ELEVATIONS.
- 2.64 AT THIS LOCATION ONLY. 96" H x 42" W x 30" D PHENOLIC ATHLETIC LOCKER WITH INTEGRATED POWER AT LOCKABLE COMPARTMENT & OPERABLE BENCH SEAT AT BASE, SEE MILLWORK DETAILS.
- 2.66 BUILT-IN MILLWORK WITH GYPSUM METAL STUD FRAMING ABOVE. REFER TO DETAIL 11/A10.01.

	EQUIPMENT SCHEDULE						
MARK	DESCRIPTION	MANUFACTURER	B.O.D. MODEL	DIMENSIONS (WxDxH)	PROVIDED BY	<b>INSTALLED BY</b>	COMMENTS
E1	REFRIGERATOR W/ BOTTOM FREEZER	TBD	TBD	3'-0" x 3'-0" x 7'-0"	OWNER	OWNER	
E2	MICROWAVE	TBD	TBD	2'-0" x 1'-4" x 2'-6"	OWNER	OWNER	
E3	UNDERCOUNTER DISHWASHER	TBD	TBD		OWNER	CONTRACTOR	PANEL READY APPLIANCE . PROVIDE PANEL TO MATCH ADJACENT MILLWORK.
E4	ICE MACHINE	TBD	TBD	2'-6" x 3'-0" x 6'-0"	OWNER	OWNER	

MARK	DESCRIPTION	MANUFACTURER	MODEL	COMMENTS
1	18" GRAB BAR	BOBRICK	B-150C. MBLK SERIES	BAR IN VERTICAL POSITION
2	36" GRAB BAR	BOBRICK	B-150C. MBLK SERIES	
3	42" GRAB BAR	BOBRICK	B-150C. MBLK SERIES	
4	SRF. MOUNTED TOILET PAPER DISPENSER	BOBRICK	B-3588.MBLK	PROVIDED BY OWNER .G.C TO INSTALL & FIELD VERIFY LOCATION WITH OWNER.
5	SRF. MOUNTED SOAP DISPENSER	BOBRICK	B-2012.MBLK	PROVIDED & INSTALLED BY OWNER.
6	SRF. MOUNTED PAPER TOWEL DISPENSER	BOBRICK	B-9262.MBLK	PROVIDED BY OWNER .G.C TO INSTALL & FIELD VERIFY LOCATION WITH OWNER.
7	SRF. MOUNTED TOWEL HOOK	BOBRICK	B-7671.MBLK	MOUNT AT 86" A.F.F. CENTER ON STUD U.O.N. PROVIDE BLOCKING
8	CUSTOM SIZED PLATE GLASS MIRROR			SECURED WITH CONCEALED FASTENERS - REFER TO INTERIOR ELEVATIONS FOR PANEL SIZE & JOINTS.
9	SHOWER CURTAIN & ROD	BOBRICK	ROD: B-207; CURTAIN: B-204	CENTER AT 76" A.F.F.
10	SANITARY NAPKIN DISPOSAL	BOBRICK	B-35139.MBLK	PROVIDED & INSTALLED BY OWNER.
11	36" WIDE TOILET PARTITION, TYP	BRADLEY CORPORATION	SEE SPECIFICATIONS	
12	60" WIDE ADA TOILET PARTITION, TYP	BRADLEY CORPORATION	SEE SPECIFICATIONS	
13	SRF. MOUNTED URINAL PARTITION	BRADLEY CORPORATION	SEE SPECIFICATIONS	
14	18" GRAB BAR	BOBRICK	B-150C. MBLK SERIES	BAR IN HORIZONTAL POSITION
15	24" GRAB BAR	BOBRICK	B-150C. MBLK SERIES	
16	WALL MOUNTED FOOT LEDGE	KOHLER	K-23287	MOUNT AT 16" A.F.F.
17	COUNTER-MOUNTED CIRCULAR WASTE CHUTE	BOBRICK	B-532	
18	CORNER SHOWER SHELVES	SCHLUTER	SHELF E WAVE	2 EACH SHOWER MOUNTED AT 40" & 56" AFF. FINISH MATTE BLACK.
20	ADA SHOWER SEAT			
	+			

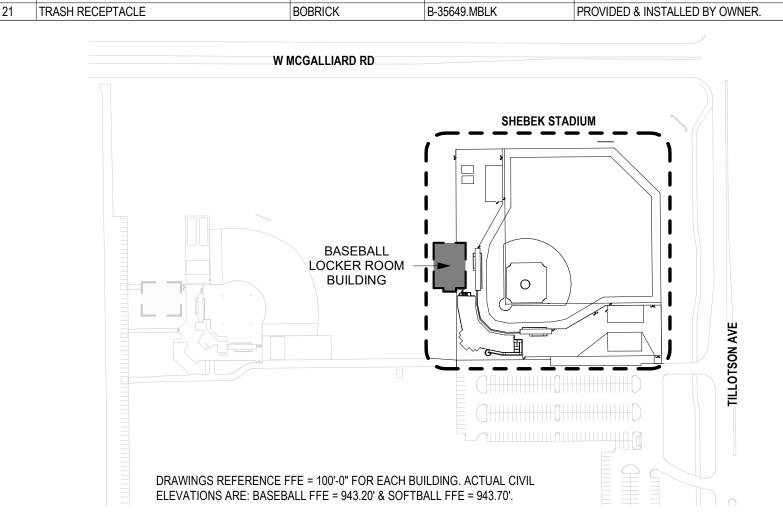

KEY PLAN - BASEBALL COMPLEX

1" = 200'-0"

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**NILDING**  $\mathbf{\Omega}$ 

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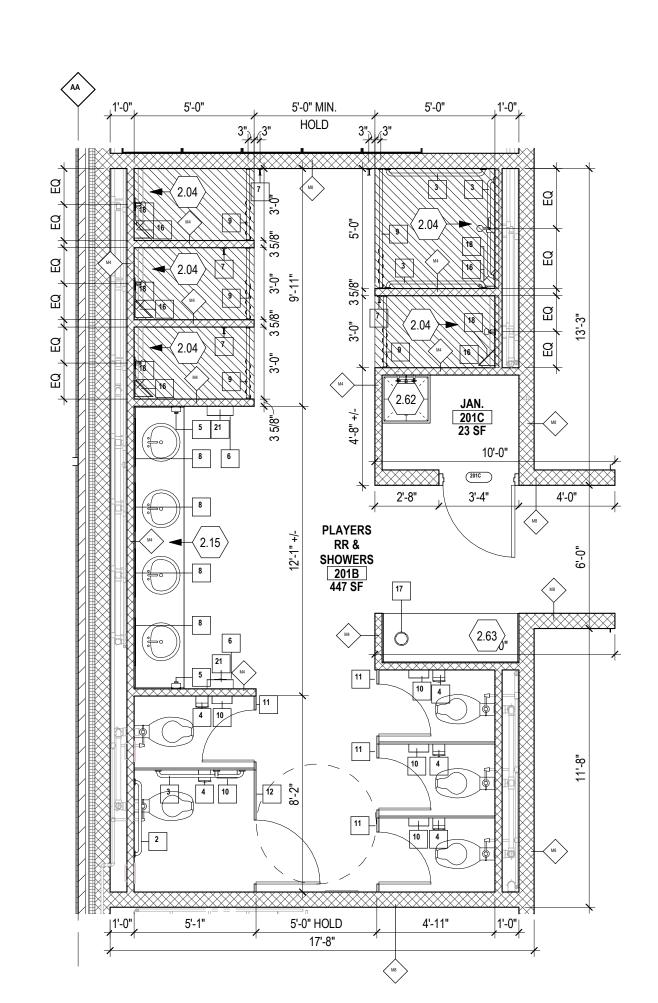
PROJECT NO.

DRAWING TITLE: CONSTRUCTION PLAN - BASEBALL BUILDING


A2.00B

ENLARGED PLAN - SATELLITE P.T. & NUTRITION

A2.00S 1/4" = 1'-0"




**TENLARGED PLAN - PLAYERS RR & SHOWERS** 

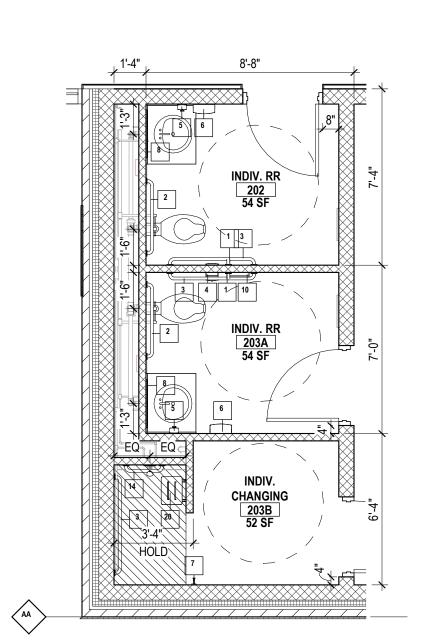

ENLARGED PLAN - INDIV. RR & SHOWERS

A2.00S 1/4" = 1'-0"

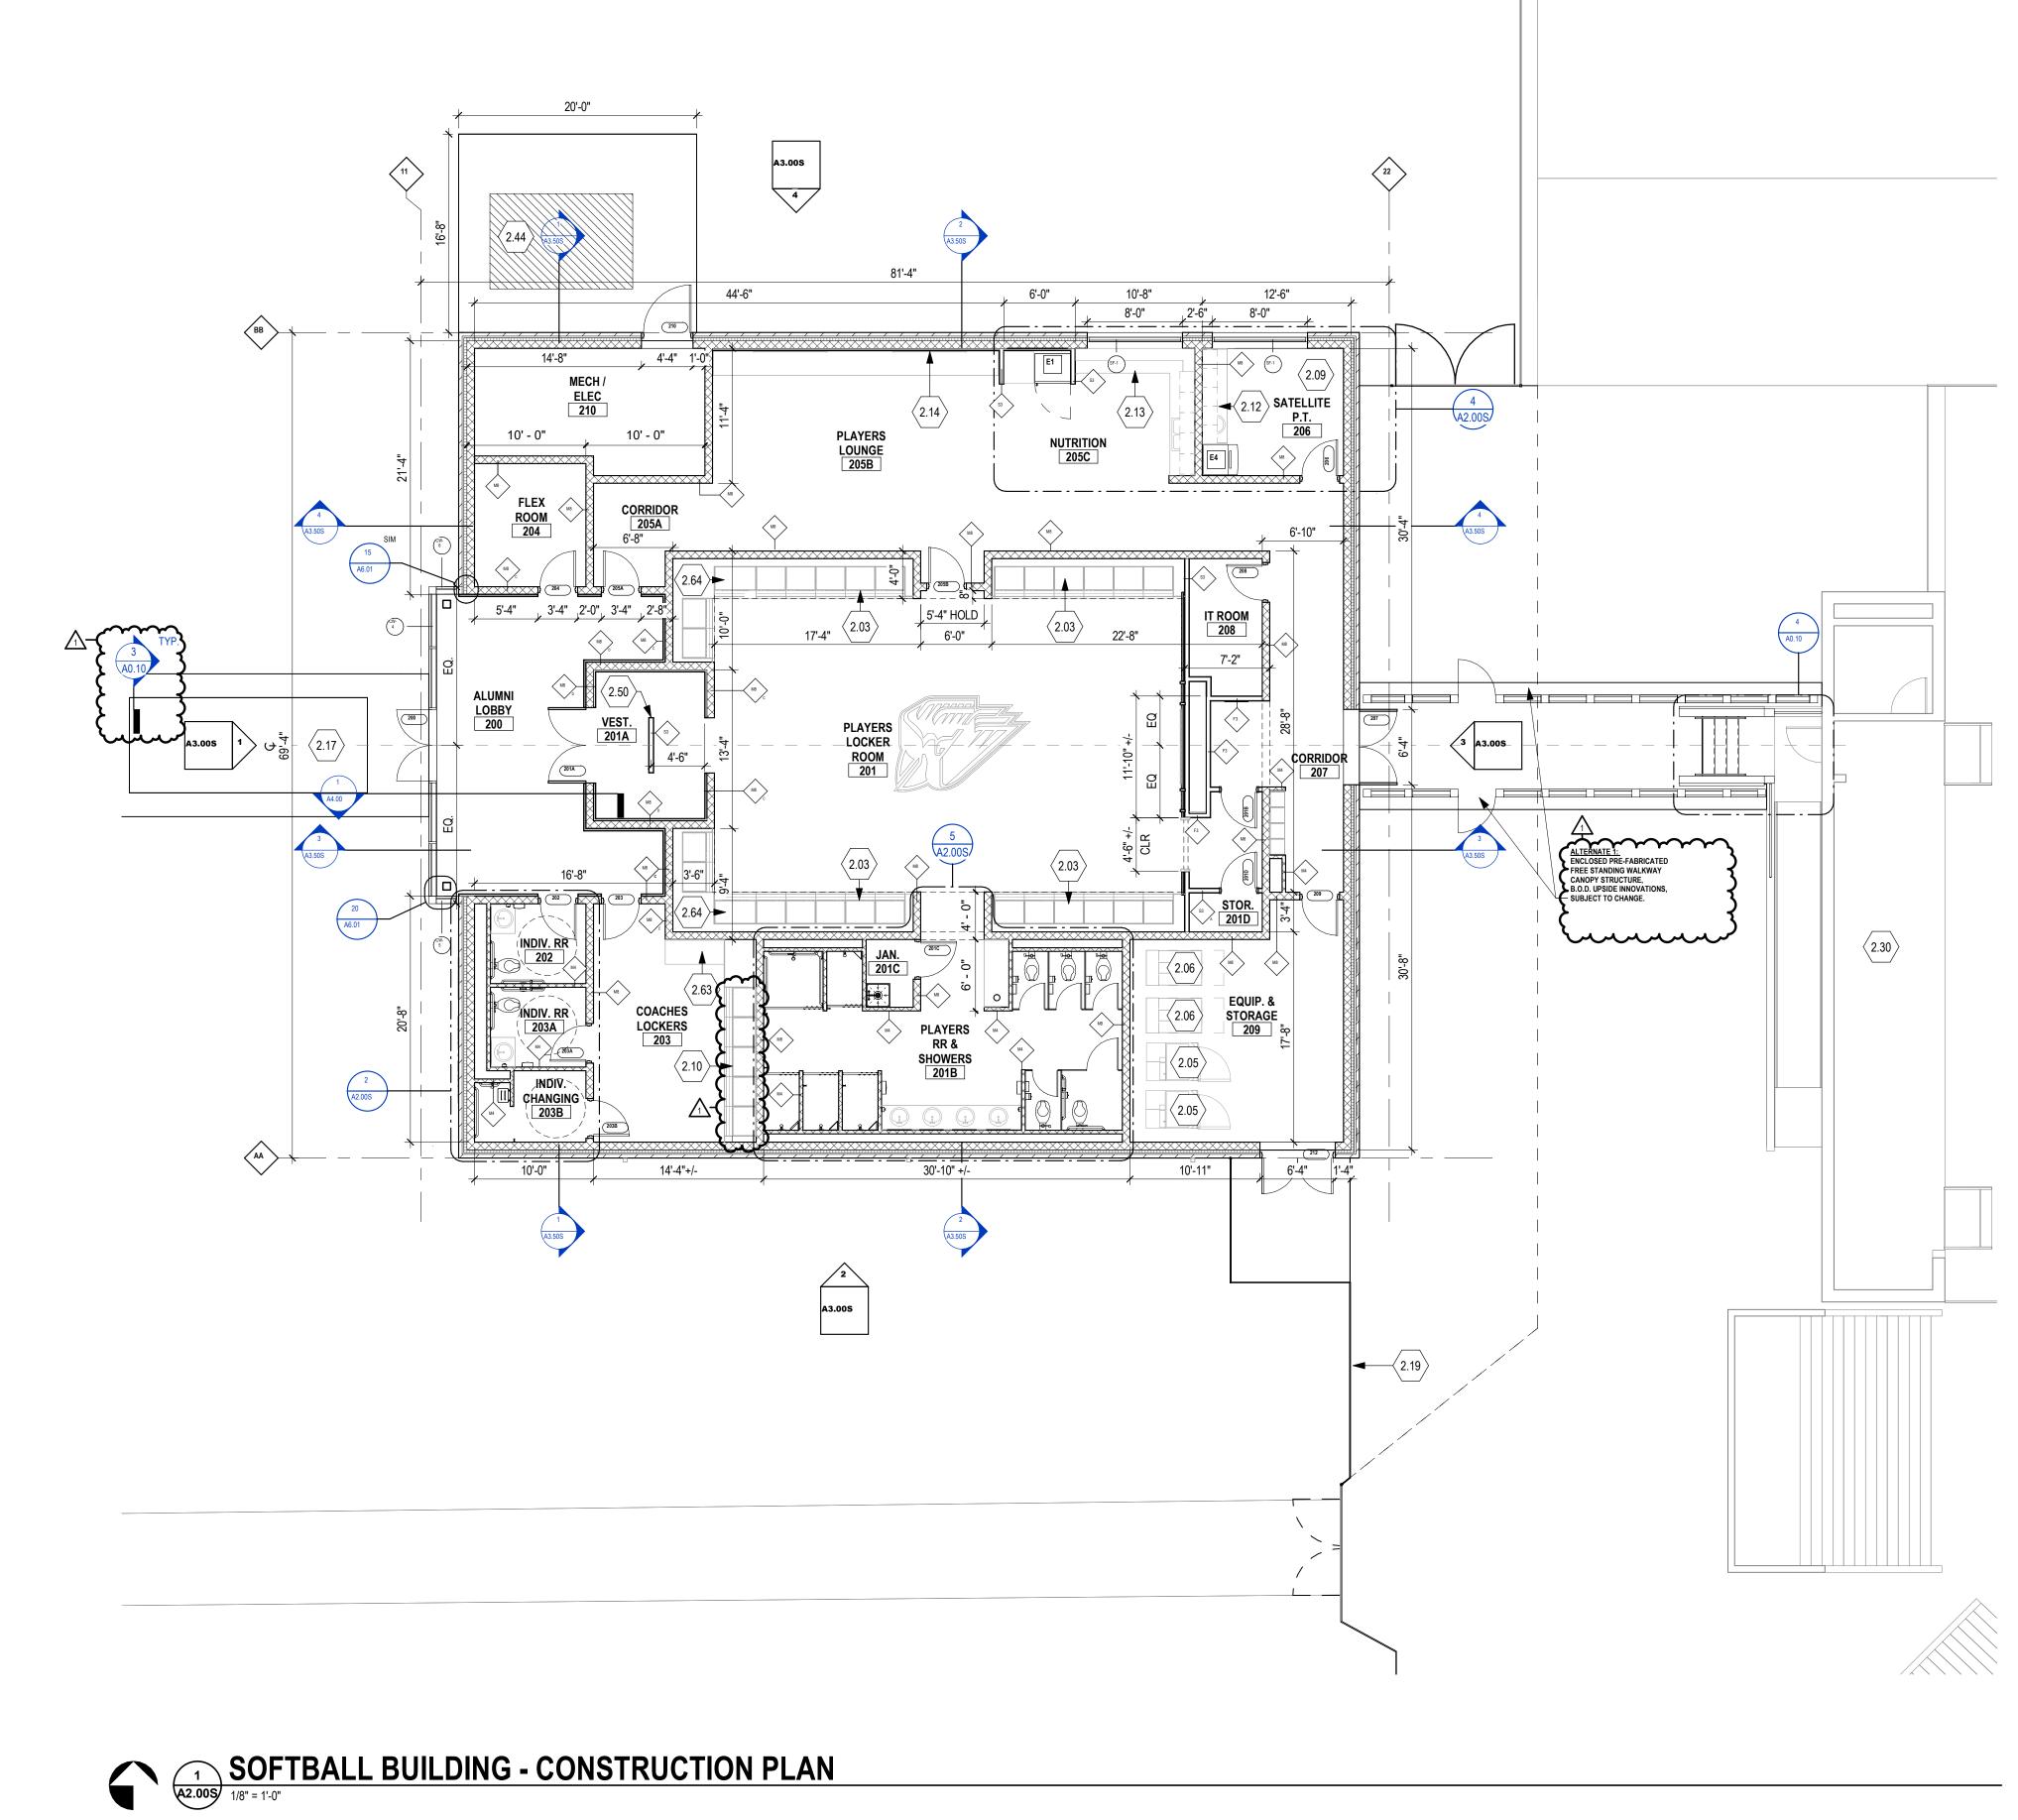

## **GENERAL CONSTRUCTION NOTES**

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- F. ALL DOORS IN METAL STUD PARTITIONS TO BE LOCATED WITH OUTSIDE EDGE OF THE FRAME 4" FROM PERPENDICULAR WALL. ALL MASONRY OPENINGS CREATED FOR NEW DOORS TO BE LOCATED 8" FROM PERPENDICULAR WALL. TYPICAL UNLESS NOTED OTHERWISE.
- G. ALL INTERIOR WALLS GO TO ROOF DECK, UNLESS NOTED OTHERWISE. H. WHEN INFILLING AN OPENING WITHIN A MASONRY WALL, TOOTH-IN MASONRY TO MATCH EXISTING COURSING, UNLESS NOTED OTHERWISE.
- I. ALL INTERIOR DIMENSIONS ARE TO FACE OF SHEATHING AND/OR FACE OF INTERIOR MASONRY, UNLESS NOTED OTHERWISE. COORDINATE FINAL PARITION LOCATIONS WITH FURRING AT STRUCTURAL ELEMENTS. K. COORDINATE INTERIOR CONCRETE SLAB ON GRADE CONTROL JOINT PATTERN AT ALL HARD-TILED SURFACE AREAS WITH ARCHITECT.
- L. ALL EXTERIOR DIMENSIONS ARE TO FACE OF FOUNDATION, FACE OF EXTERIOR SHEATHING, AND/OR FACE OF EXTERIOR MASONRY.
- M. PROVIDE 1/2" RADIUS BULLNOSE CMU UNITS AT ALL EXPOSED OUTSIDE CORNERS, TYPICAL UNLESS NOTED OTHERWISE. N. PAINT ALL EXPOSED EXTERIOR LINTELS TO MATCH THE BRICK MASONRY.

## **KEYNOTES - CONSTRUCTION**


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- 2.05 APPROX. LOCATION OF FUTURE INDUSTRIAL GRADE WASHER UNITS, BY OWNER. CONTRACTOR TO PROVIDE ALL ROUGH-INS & CONCRETE EQUIPMENT PAD, AS NEEDED. REFER TO ELECTRICAL & PLUMBING DRAWINGS FOR FULL EXTENT OF WORK.
- 2.06 APPROX. LOCATION OF FUTURE INDUSTRIAL GRADE DRYER UNITS, BY OWNER. CONTRACTOR TO PROVIDE ALL ROUGH-INS & CONCRETE EQUIPMENT PAD, AS NEEDED. REFER TO ELECTRICAL & PLUMBING DRAWINGS FOR FULL EXTENT OF WORK.
- 2.08 SOLID SURFACE MILLWORK WITH UNDERMOUNT SINK. REFER TO MILLWORK DETAILS.
- 2.13 QUARTZ COUNTERTOP OVER BASE CABINETS WITH UNDERMOUNT SINK AND KITCHEN APPLIANCES. TBD BY OWNER. 2.14 LOCATION OF WALL-MOUNTED TV BY OWNER @ 5'-0" AFF ON CENTER U.O.N. PROVIDE IN-WALL CLOCKING AND POWER/DATA. REFER TO ELECTRICAL DRAWINGS.
- 2.15 SOLID SURFACE COUNTERTOP WITH UNDERMOUNT SINKS & WALL MOUNTED ACCESSORIES.
- 2.17 NEW BELDEN ADMIRAL RED BRICK PAVERS. SQUARE EDGES 2 1/4" X 4" X 8". 2.19 NEW DECORATIVE FENCING AND GATE WHEN APPLICABLE, TO MATCH EXISTING FENCING (6' HIGH TYP).
- 2.30 EXISTING DUGOUT AND ACCESS RAMP TO REMAIN. PROTECT DURING CONSTRUCTION.
- 2.44 CONCRETE PAD FOR MECHINICAL UNIT. REFER TO MECHANICAL DRAWINGS.
- 2.50 STANDALONE DIVIDER WALL. PROVIDE EXTRA WOOD BLOCKING
- 2.62 MOP SINK. REFER TO PLUMBING DRAWINGS. 2.63 BUILT IN SOLID SERVICE WORK COUNTER. REFER TO INTERIOR ELEVATIONS.
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	EQUIPMENT SCHEDULE						
MARK	DESCRIPTION	MANUFACTURER	B.O.D. MODEL	DIMENSIONS (WxDxH)	PROVIDED BY	INSTALLED BY	COMMENTS
1	REFRIGERATOR W/ BOTTOM FREEZER	TBD	TBD	3'-0" x 3'-0" x 7'-0"	OWNER	OWNER	
E2	MICROWAVE	TBD	TBD	2'-0" x 1'-4" x 2'-6"	OWNER	OWNER	
E3	UNDERCOUNTER DISHWASHER	TBD	TBD		OWNER		PANEL READY APPLIANCE . PROVIDE PANEL TO MATCH ADJACENT MILLWORK.

2'-6" x 3'-0" x 6'-0" OWNER OWNER

MARK	DESCRIPTION	MANUFACTURER	MODEL	COMMENTS
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16	WALL MOUNTED FOOT LEDGE	KOHLER	K-23287	MOUNT AT 16" A.F.F.
17	COUNTER-MOUNTED CIRCULAR WASTE CHUTE	BOBRICK	B-532	
18	CORNER SHOWER SHELVES	SCHLUTER	SHELF E WAVE	2 EACH SHOWER MOUNTED AT 40" & 56" AFF. FINISH MATTE BLACK.
20	ADA SHOWER SEAT			


PROVIDED & INSTALLED BY OWNER.

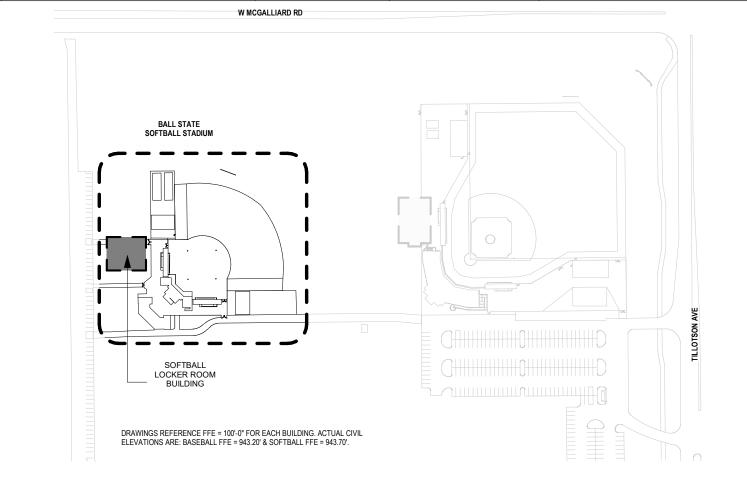

KEY PLAN - SOFTBALL COMPLEX

21 TRASH RECEPTACLE

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PROJECT NO.

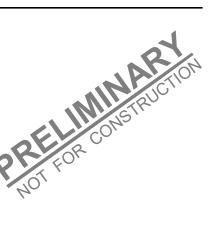DRAWING TITLE: CONSTRUCTION PLAN - SOFTBALL BUILDING

**A2.00S** 

- A. ALL DIMENSIONS THAT ARE +/- OR ± (PLUS OR MINUS) ARE TO BE DETERMINED EXACTLY BY FIELD MEASUREMENT. B. ALL DIMENSIONS AND EXISTING CONDITIONS SHALL BE VERIFIED IN THE FIELD BEFORE PROCEEDING WITH THE WORK. ARCHITECT SHALL BE
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- PROVIDE 1/2" RADIUS BULLNOSE CMU UNITS AT ALL EXPOSED OUTSIDE CORNERS, TYPICAL UNLESS NOTED OTHERWISE.
- N. PAINT ALL EXPOSED EXTERIOR LINTELS TO MATCH THE BRICK MASONRY.


## **KEYNOTES - CONSTRUCTION**

## **ELEVATION MATERIAL LEGEND**

BR1 - BRICK. MATCH TO EXISTING STRUCTURES

BR2 - BRICK, SOLDIER COURSE. MATCH TO EXISTING STRUCTURES

MP1 - AMC METAL PANEL, TYP. GRAY FINISH

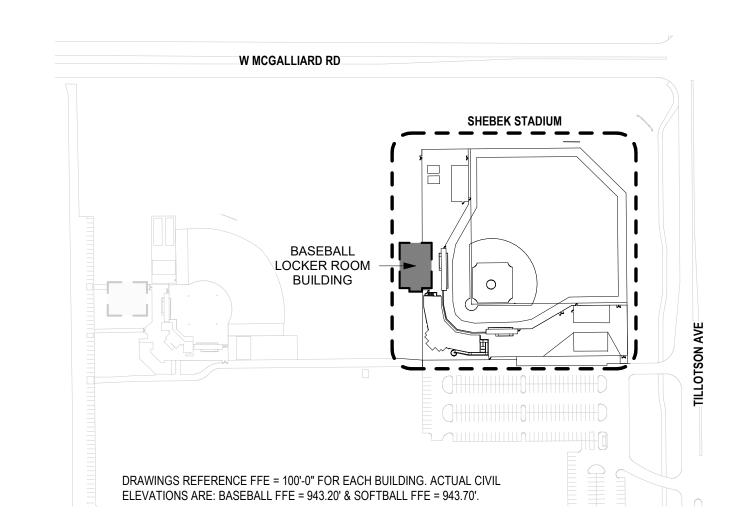

KEY PLAN - BASEBALL COMPLEX

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BUILDING LOCKER SOF

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C 11/21/2025 BID/PERMIT SET 1 12/15/2025 ADDENDUM 2

PROJECT NO.

DRAWING TITLE **EXTERIOR ELEVATIONS -**

BASEBALL BUILDING

A3.00B

- A. ALL DIMENSIONS THAT ARE +/- OR ± (PLUS OR MINUS) ARE TO BE DETERMINED EXACTLY BY FIELD MEASUREMENT. ALL DIMENSIONS AND EXISTING CONDITIONS SHALL BE VERIFIED IN THE FIELD BEFORE PROCEEDING WITH THE WORK. ARCHITECT SHALL BE
- NOTIFIED OF ANY DISCREPANCIES.
- ALL DIMENSIONS HAVE PREFERENCE OVER SCALE, DO NOT SCALE DRAWINGS. LARGE SCALE DETAILS, GOVERN OVER SMALL SCALE DETAILS.
- IF CONTRACTOR SHOULD DISCOVER ANY UNFORSEEN PROBLEMS DURING THE REMOVAL OF ANY EXISTING CONSTRUCTION OR THE CONSTRUCTION OF ANY NEW WORK, THE ARCHITECT SHOULD BE NOTIFIED IMMEDIATELY AND THAT PARTICULAR WORK SHOULD BE DISCONTINUED UNTIL
- NECESSARY REVISIONS CAN BE DECIDED UPON. ALL DOORS IN METAL STUD PARTITIONS TO BE LOCATED WITH OUTSIDE EDGE OF THE FRAME 4" FROM PERPENDICULAR WALL. ALL MASONRY
- OPENINGS CREATED FOR NEW DOORS TO BE LOCATED 8" FROM PERPENDICULAR WALL. TYPICAL UNLESS NOTED OTHERWISE. WHEN INFILLING AN OPENING WITHIN A MASONRY WALL, TOOTH-IN MASONRY TO MATCH EXISTING COURSING, UNLESS NOTED OTHERWISE.
- ALL INTERIOR DIMENSIONS ARE TO FACE OF SHEATHING AND/OR FACE OF INTERIOR MASONRY, UNLESS NOTED OTHERWISE. COORDINATE FINAL PARITION LOCATIONS WITH FURRING AT STRUCTURAL ELEMENTS.
- COORDINATE INTERIOR CONCRETE SLAB ON GRADE CONTROL JOINT PATTERN AT ALL HARD-TILED SURFACE AREAS WITH ARCHITECT. ALL EXTERIOR DIMENSIONS ARE TO FACE OF FOUNDATION, FACE OF EXTERIOR SHEATHING, AND/OR FACE OF EXTERIOR MASONRY.
- PROVIDE 1/2" RADIUS BULLNOSE CMU UNITS AT ALL EXPOSED OUTSIDE CORNERS, TYPICAL UNLESS NOTED OTHERWISE. N. PAINT ALL EXPOSED EXTERIOR LINTELS TO MATCH THE BRICK MASONRY.


## **KEYNOTES - CONSTRUCTION**

## **ELEVATION MATERIAL LEGEND**

BR1 - BRICK. MATCH TO EXISTING STRUCTURES

BR2 - BRICK, SOLDIER COURSE. MATCH TO EXISTING STRUCTURES

MP1 - AMC METAL PANEL, TYP. GRAY FINISH

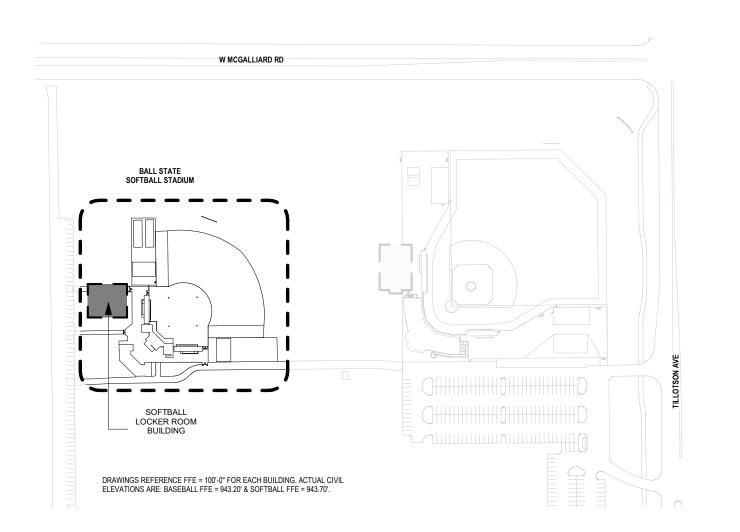



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B 06/27/2025 DD SET C 11/21/2025 BID/PERMIT SET 1 12/15/2025 ADDENDUM 2

PROJECT NO. DRAWING TITLE

**EXTERIOR ELEVATIONS -**SOFTBALL BUILDING

**A3.00S** 

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- ALL DOORS IN METAL STUD PARTITIONS TO BE LOCATED WITH OUTSIDE EDGE OF THE FRAME 4" FROM PERPENDICULAR WALL. ALL MASONRY
- ALL INTERIOR DIMENSIONS ARE TO FACE OF SHEATHING AND/OR FACE OF INTERIOR MASONRY, UNLESS NOTED OTHERWISE. COORDINATE FINAL PARITION LOCATIONS WITH FURRING AT STRUCTURAL ELEMENTS.
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- PROVIDE 1/2" RADIUS BULLNOSE CMU UNITS AT ALL EXPOSED OUTSIDE CORNERS, TYPICAL UNLESS NOTED OTHERWISE.
- N. PAINT ALL EXPOSED EXTERIOR LINTELS TO MATCH THE BRICK MASONRY.



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PROJECT NO.

DRAWING TITLE: **BUILDING SECTIONS** - BASEBALL BUILDING

KEY PLAN - BASEBALL COMPLEX

1" = 200'-0"

SHEBEK STADIUM

W MCGALLIARD RD

BASEBALL LOCKER ROOM -BUILDING

DRAWINGS REFERENCE FFE = 100'-0" FOR EACH BUILDING. ACTUAL CIVIL ELEVATIONS ARE: BASEBALL FFE = 943.20' & SOFTBALL FFE = 943.70'.

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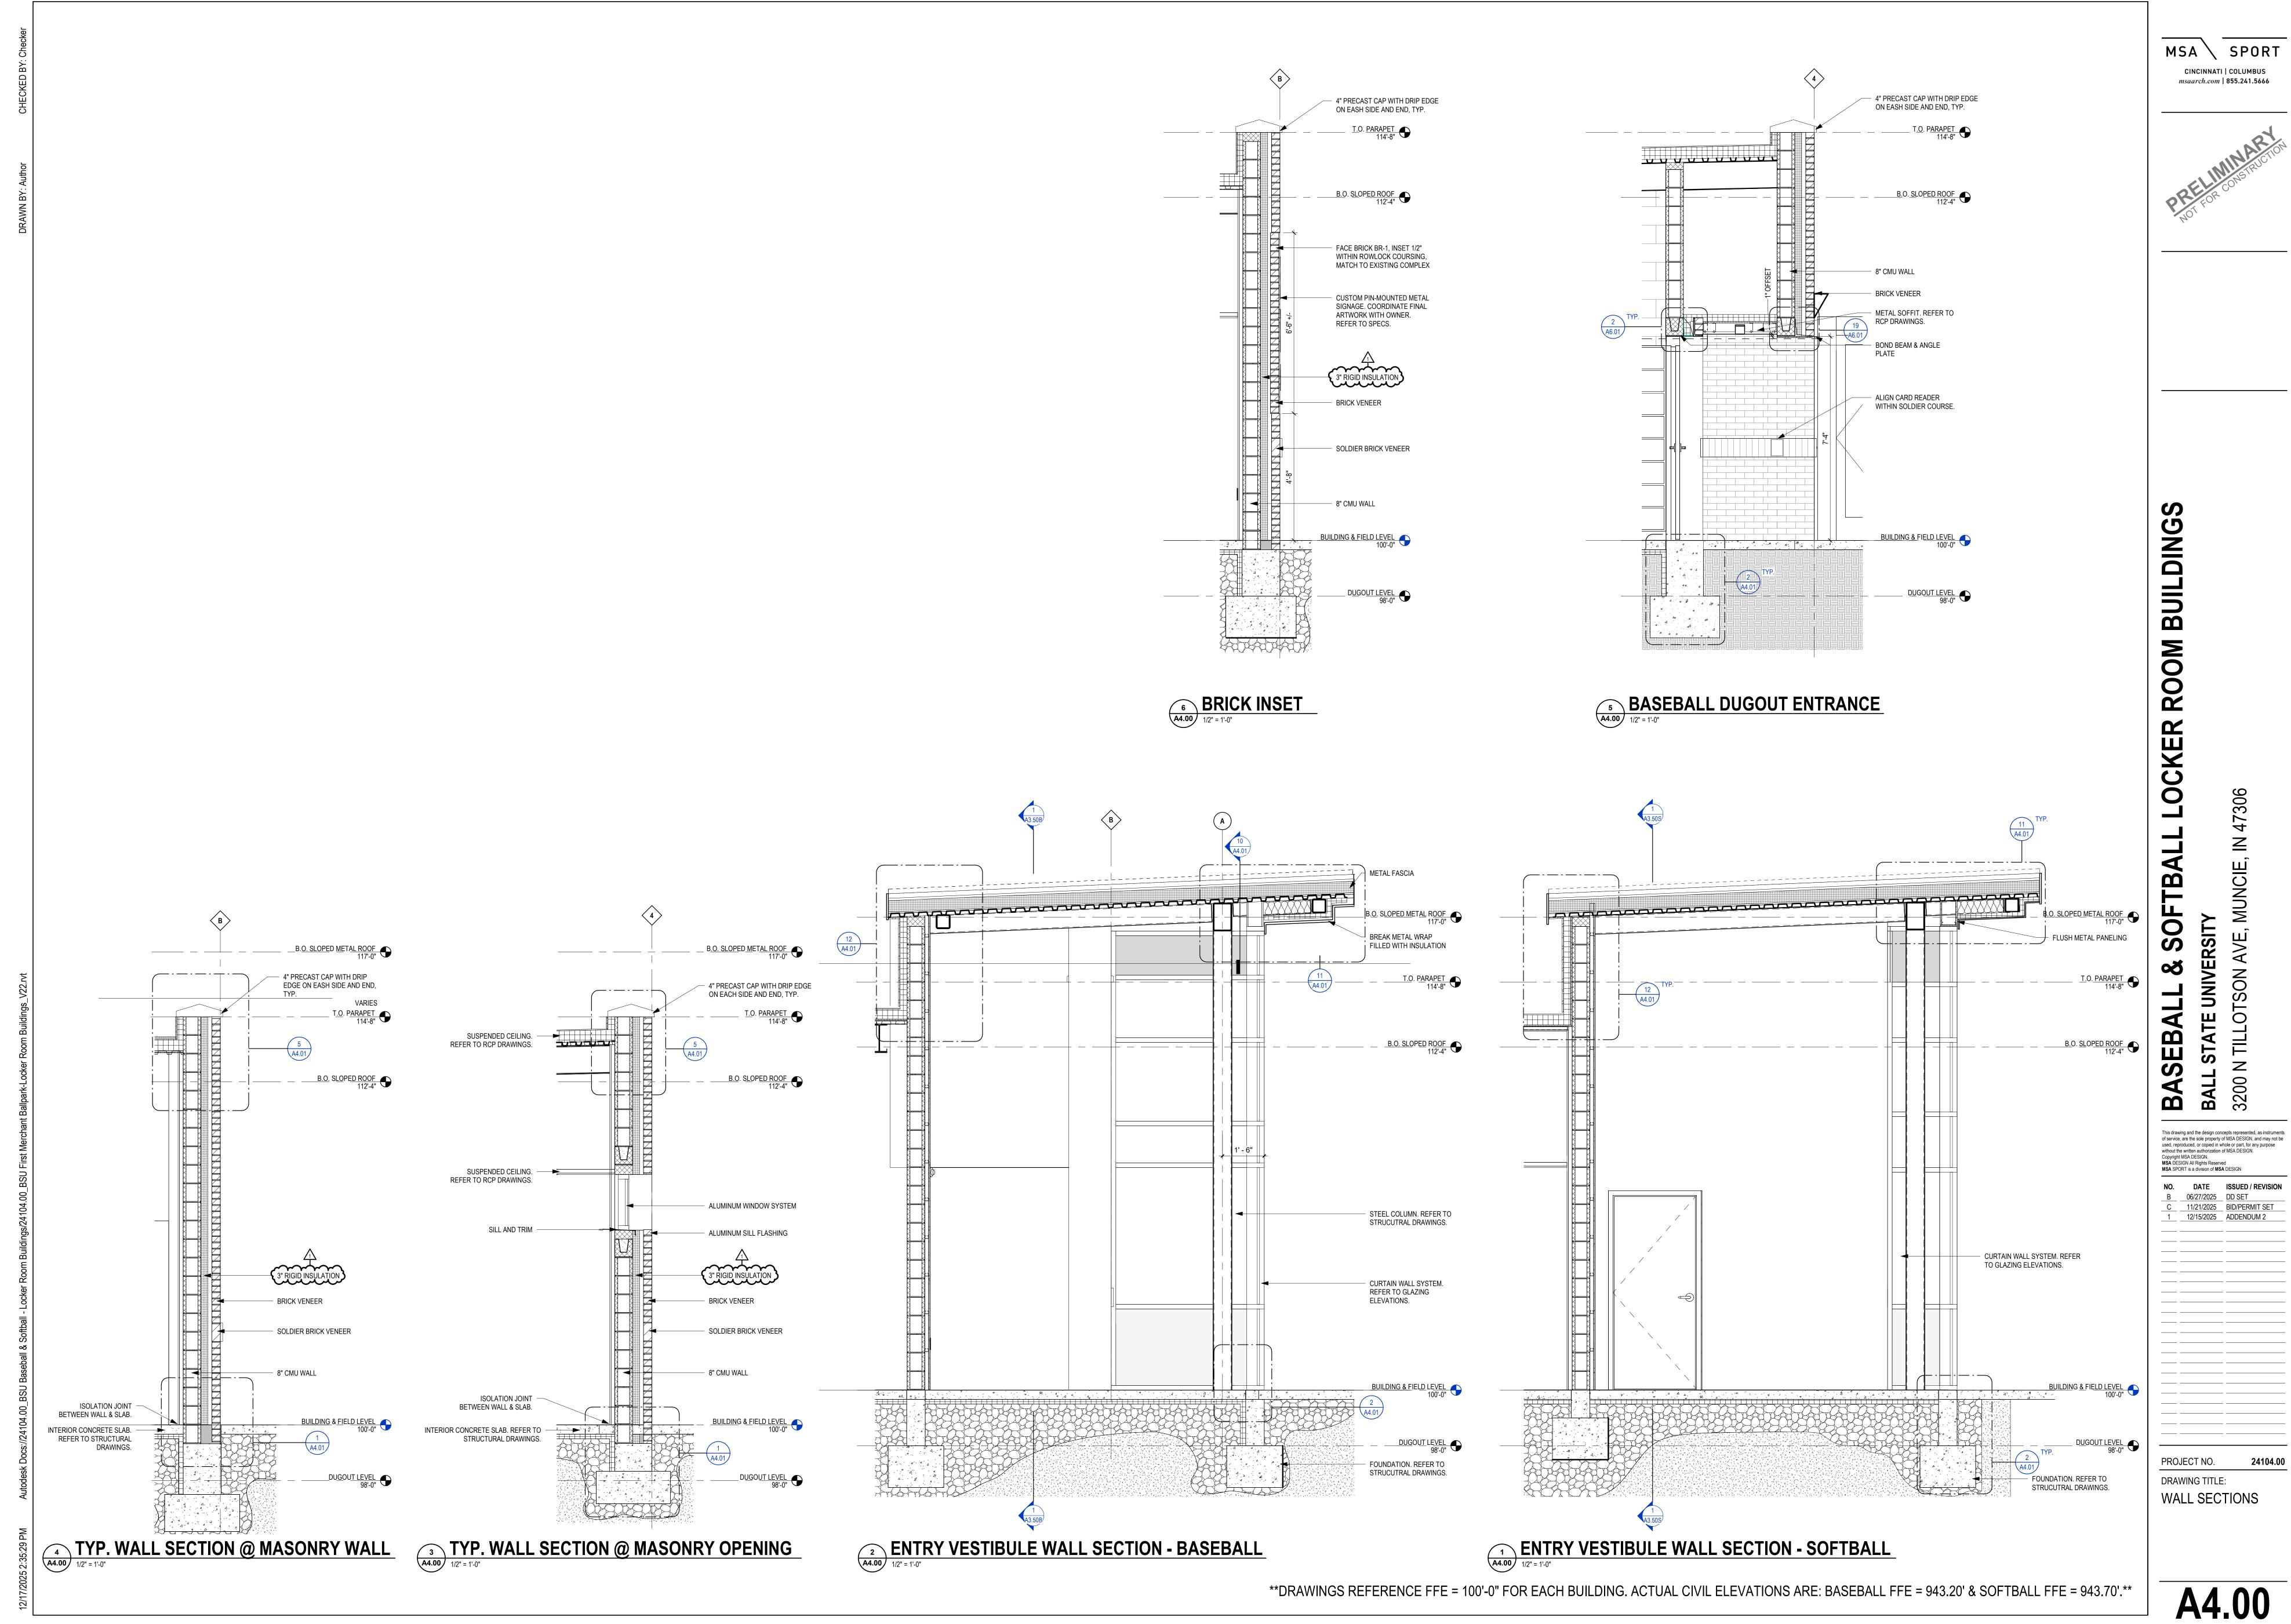
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PROJECT NO. DRAWING TITLE:

**BUILDING SECTIONS** - SOFTBALL BUILDING

KEY PLAN - SOFTBALL COMPLEX

1" = 200'-0"




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DRAWING TITLE: WALL SECTIONS

A4.00



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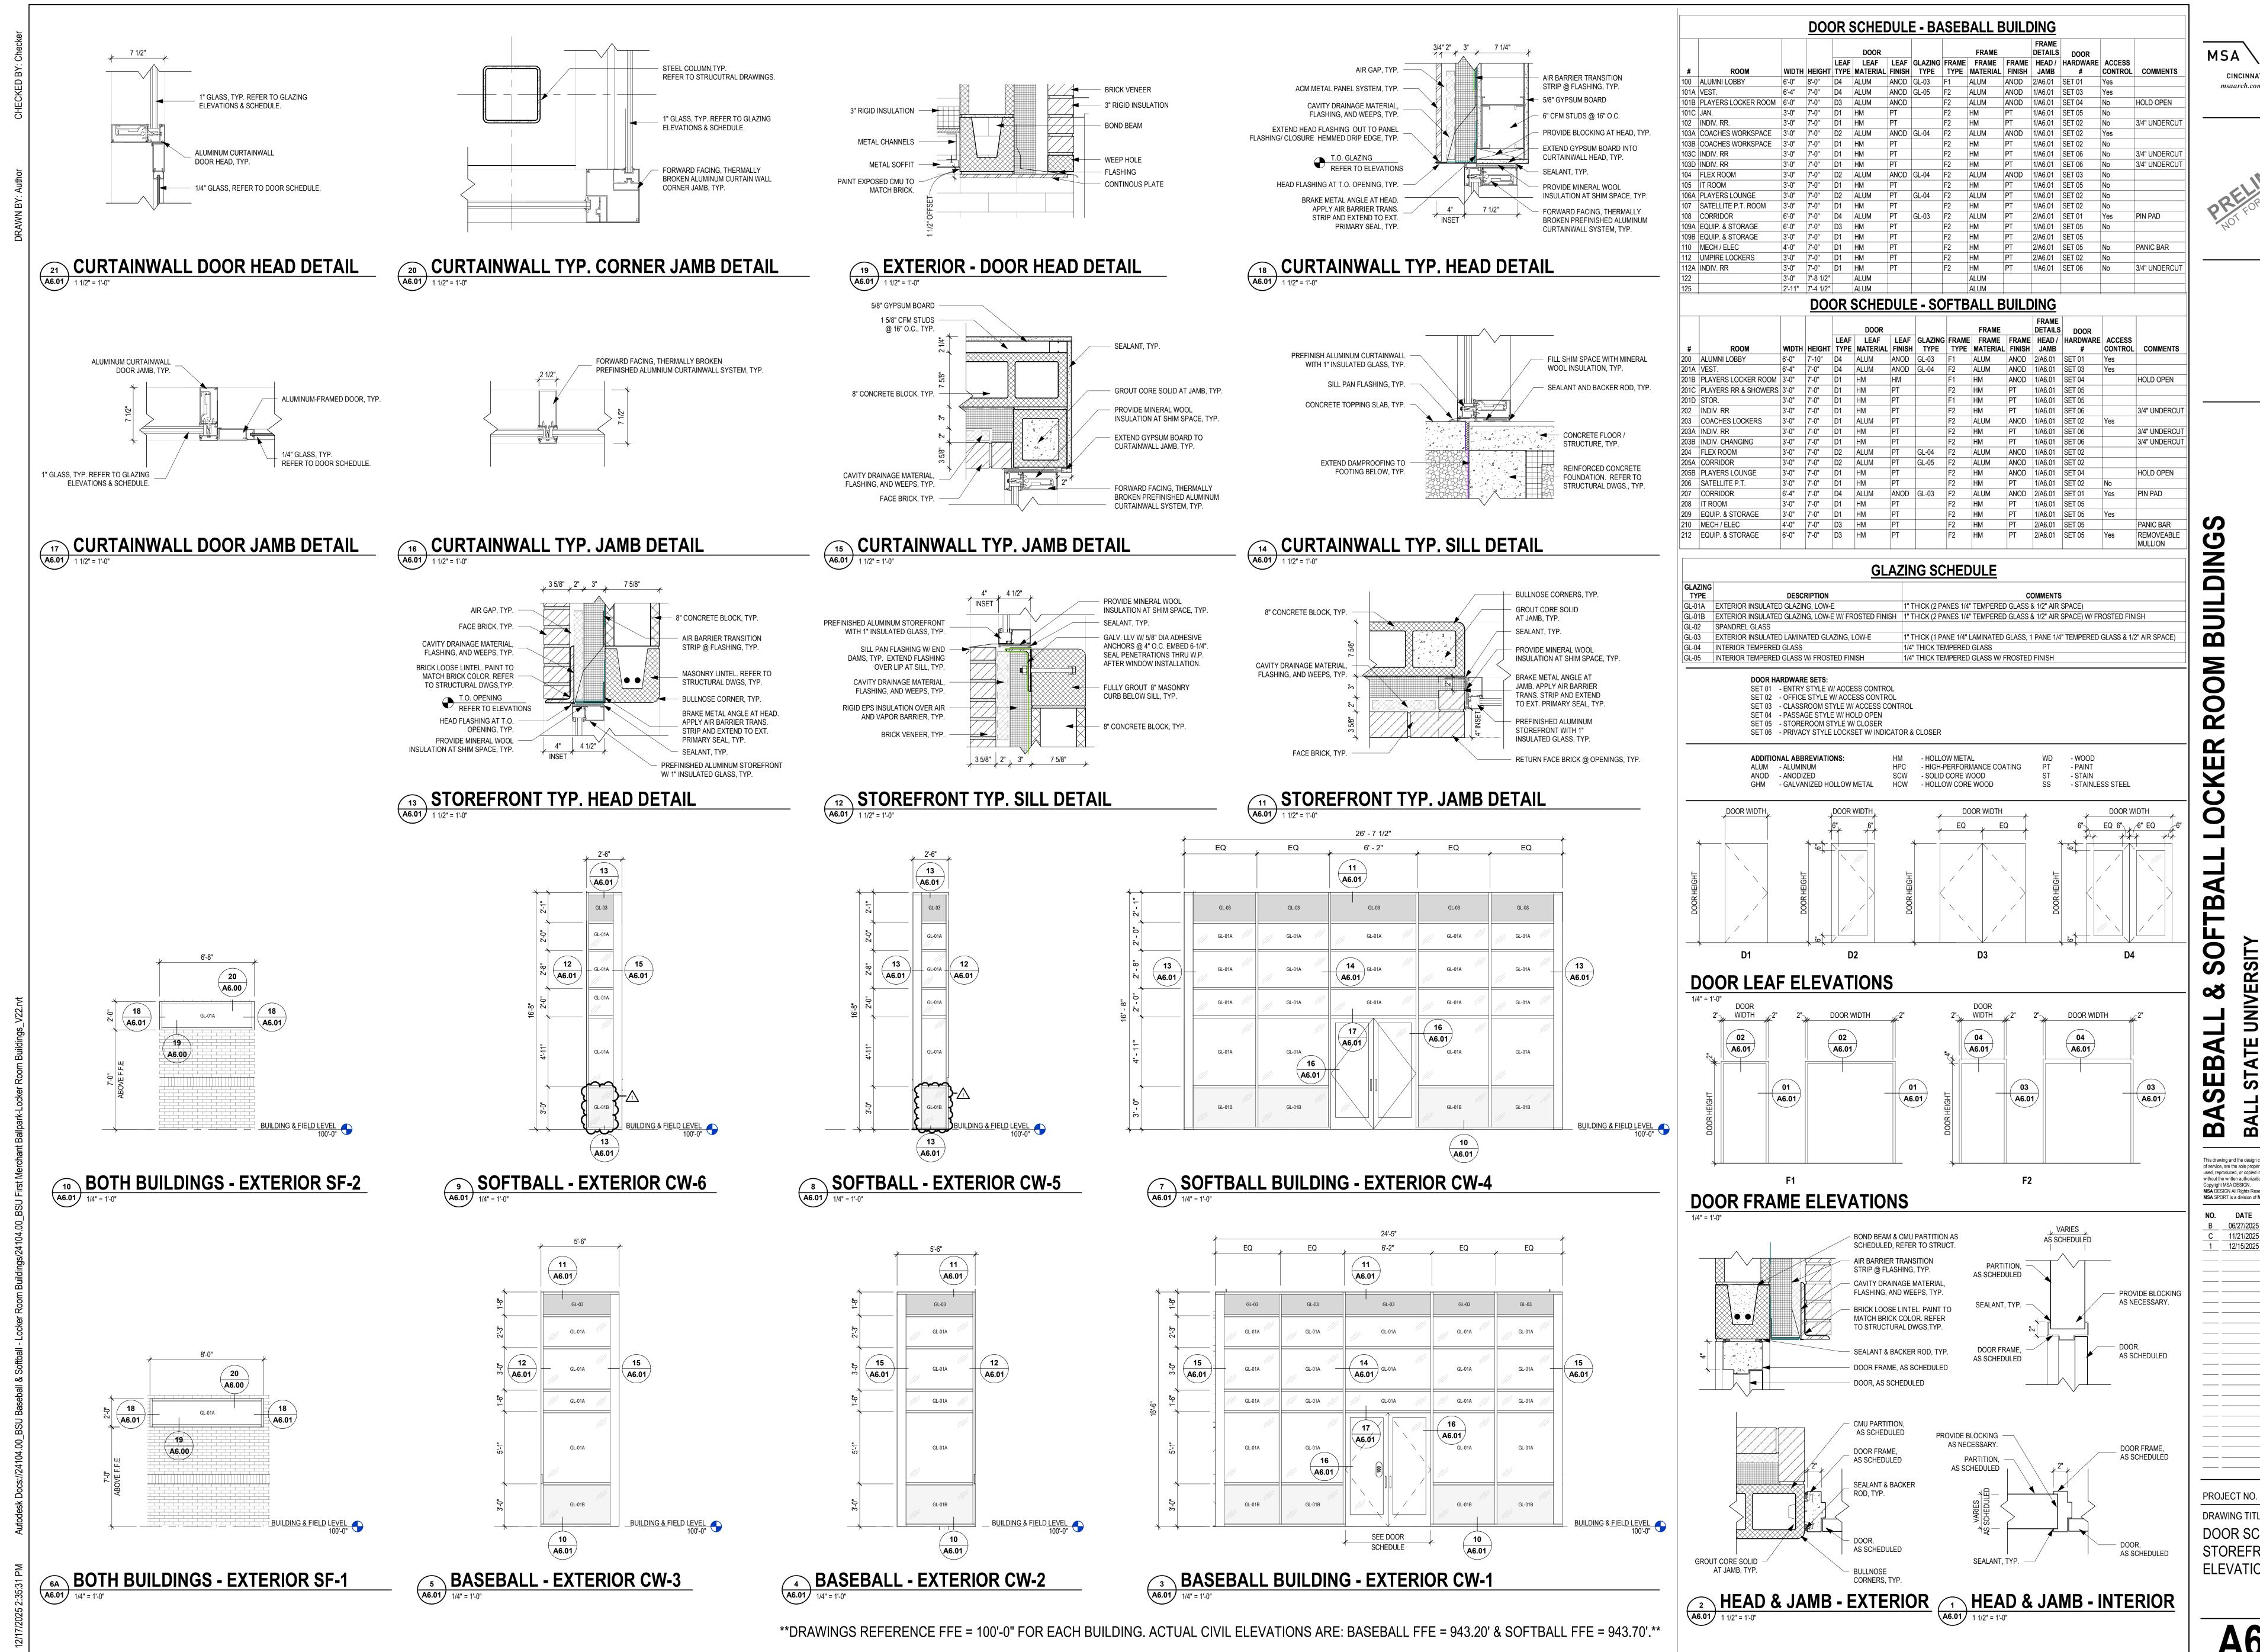
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ADDENDUM 2

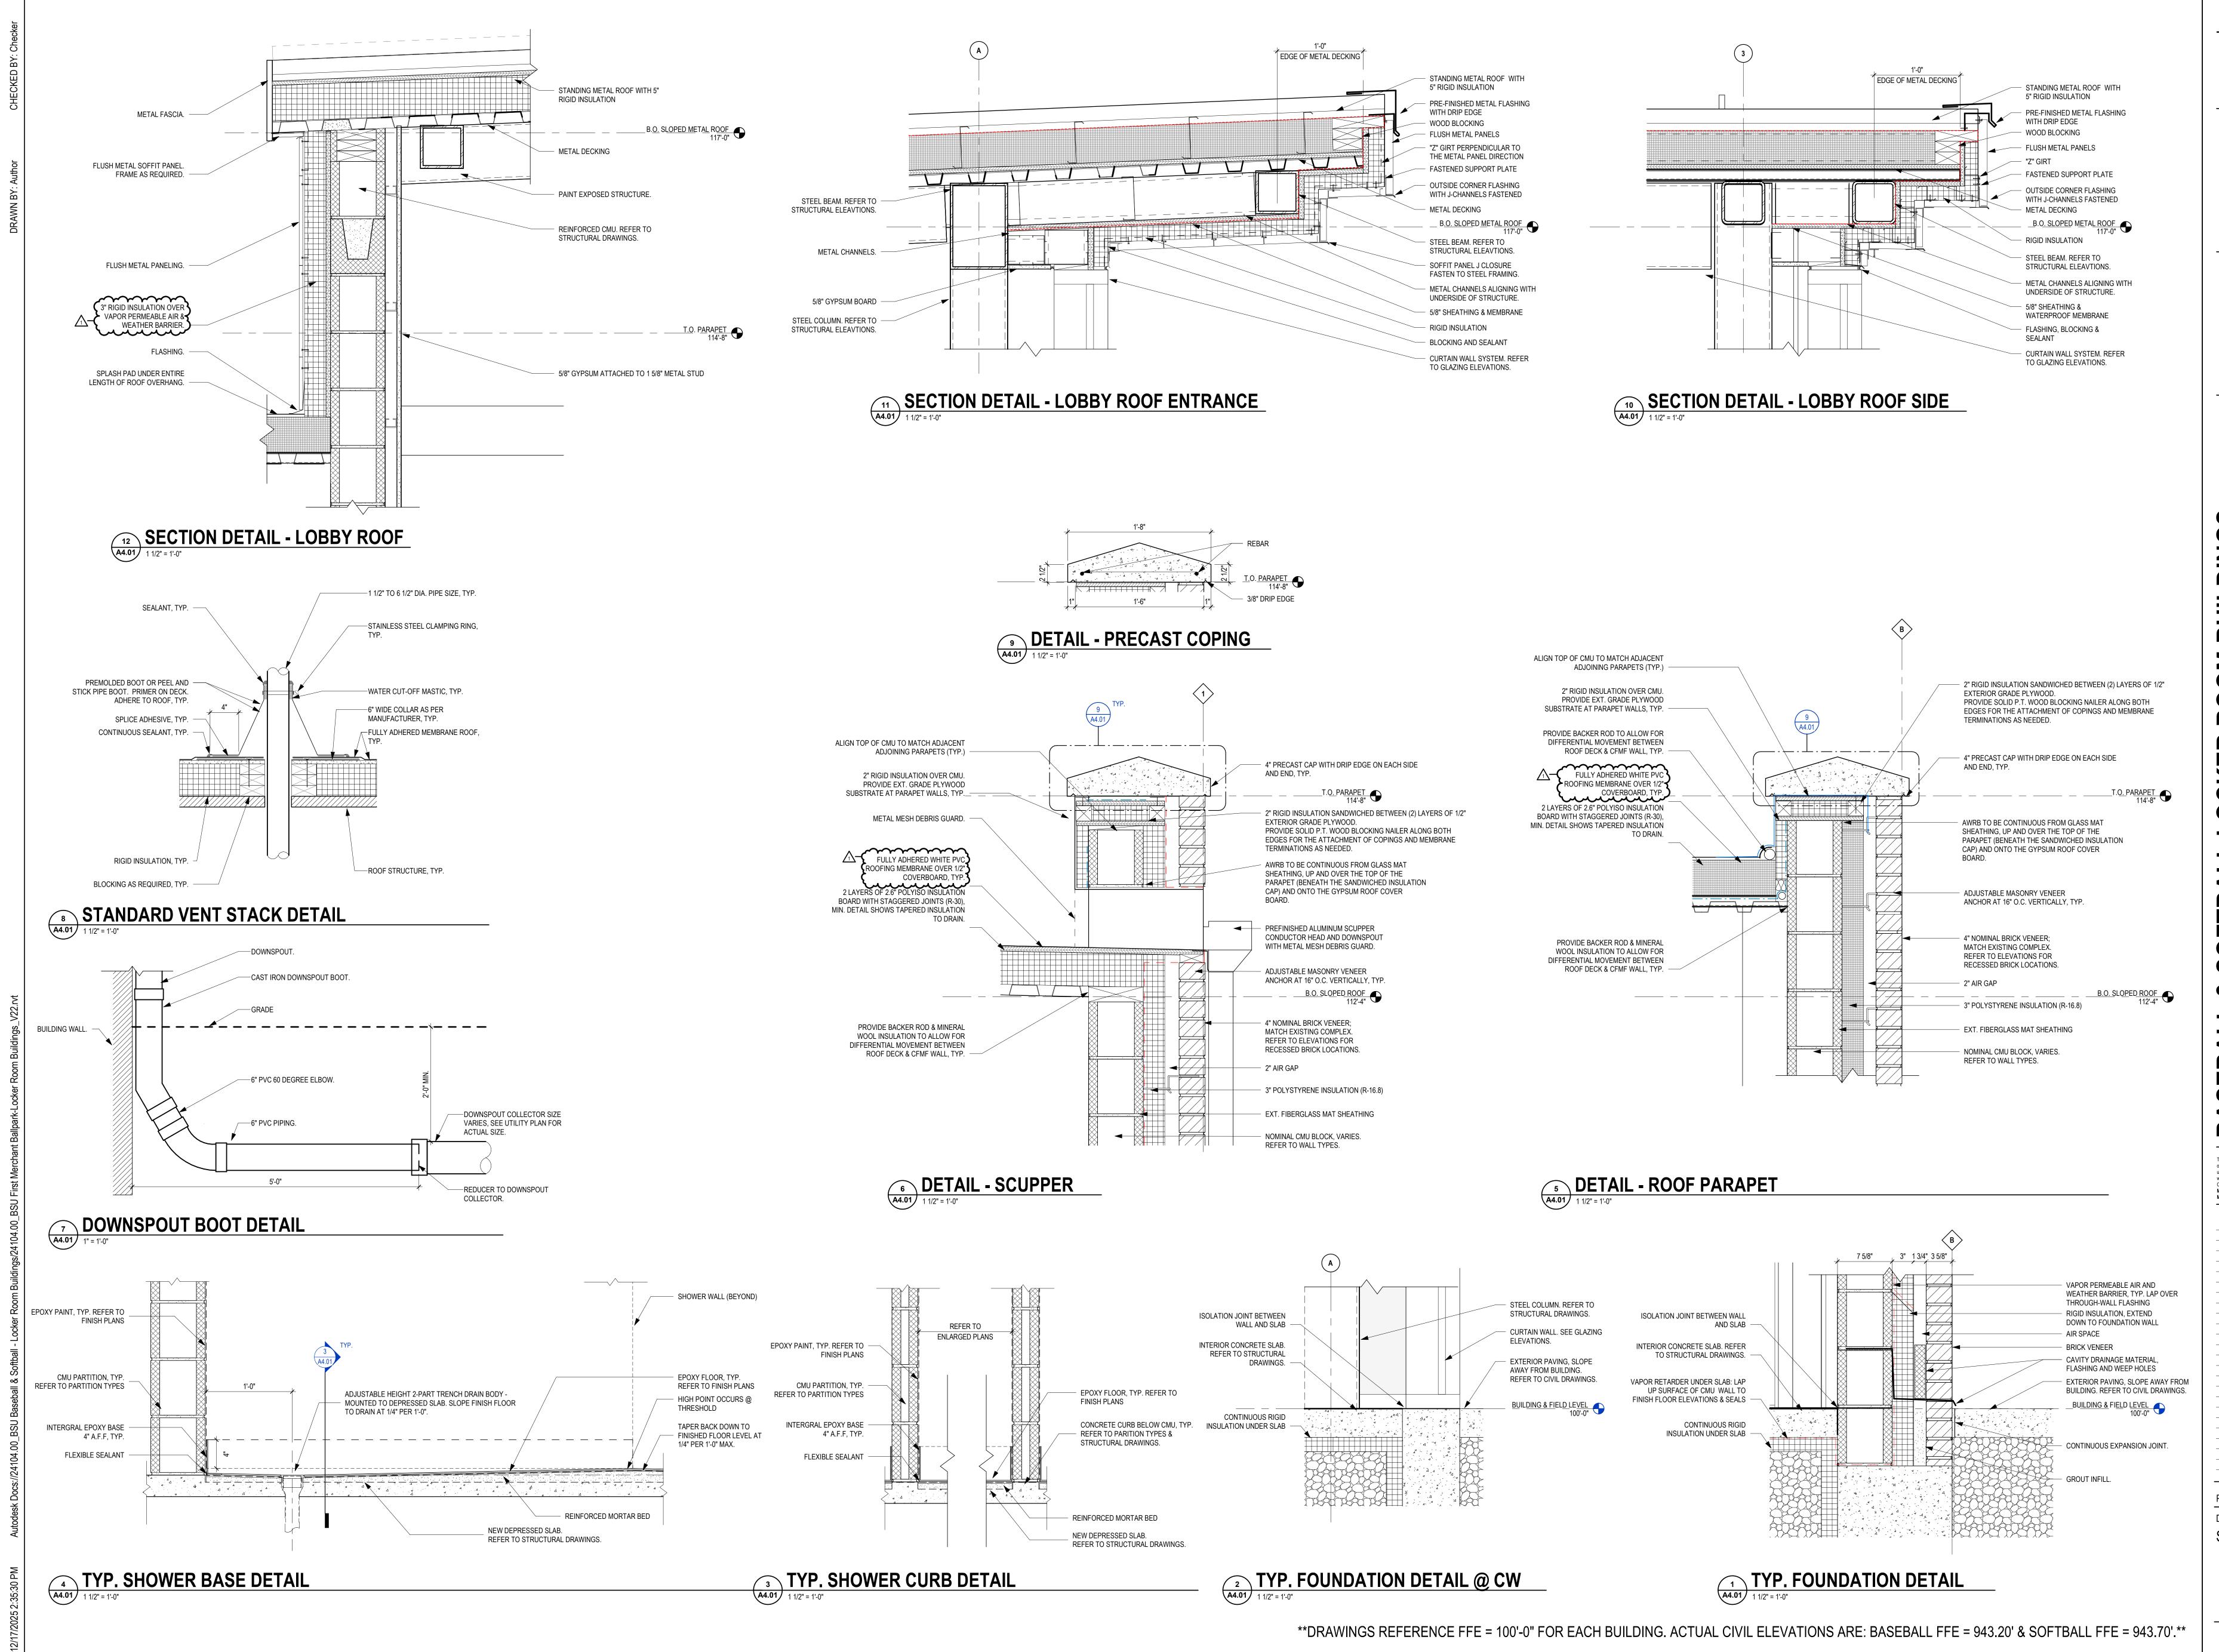PROJECT NO. 24104.0

DRAWING TITLE:
SECTION DETAILS

A4.01



A6.01

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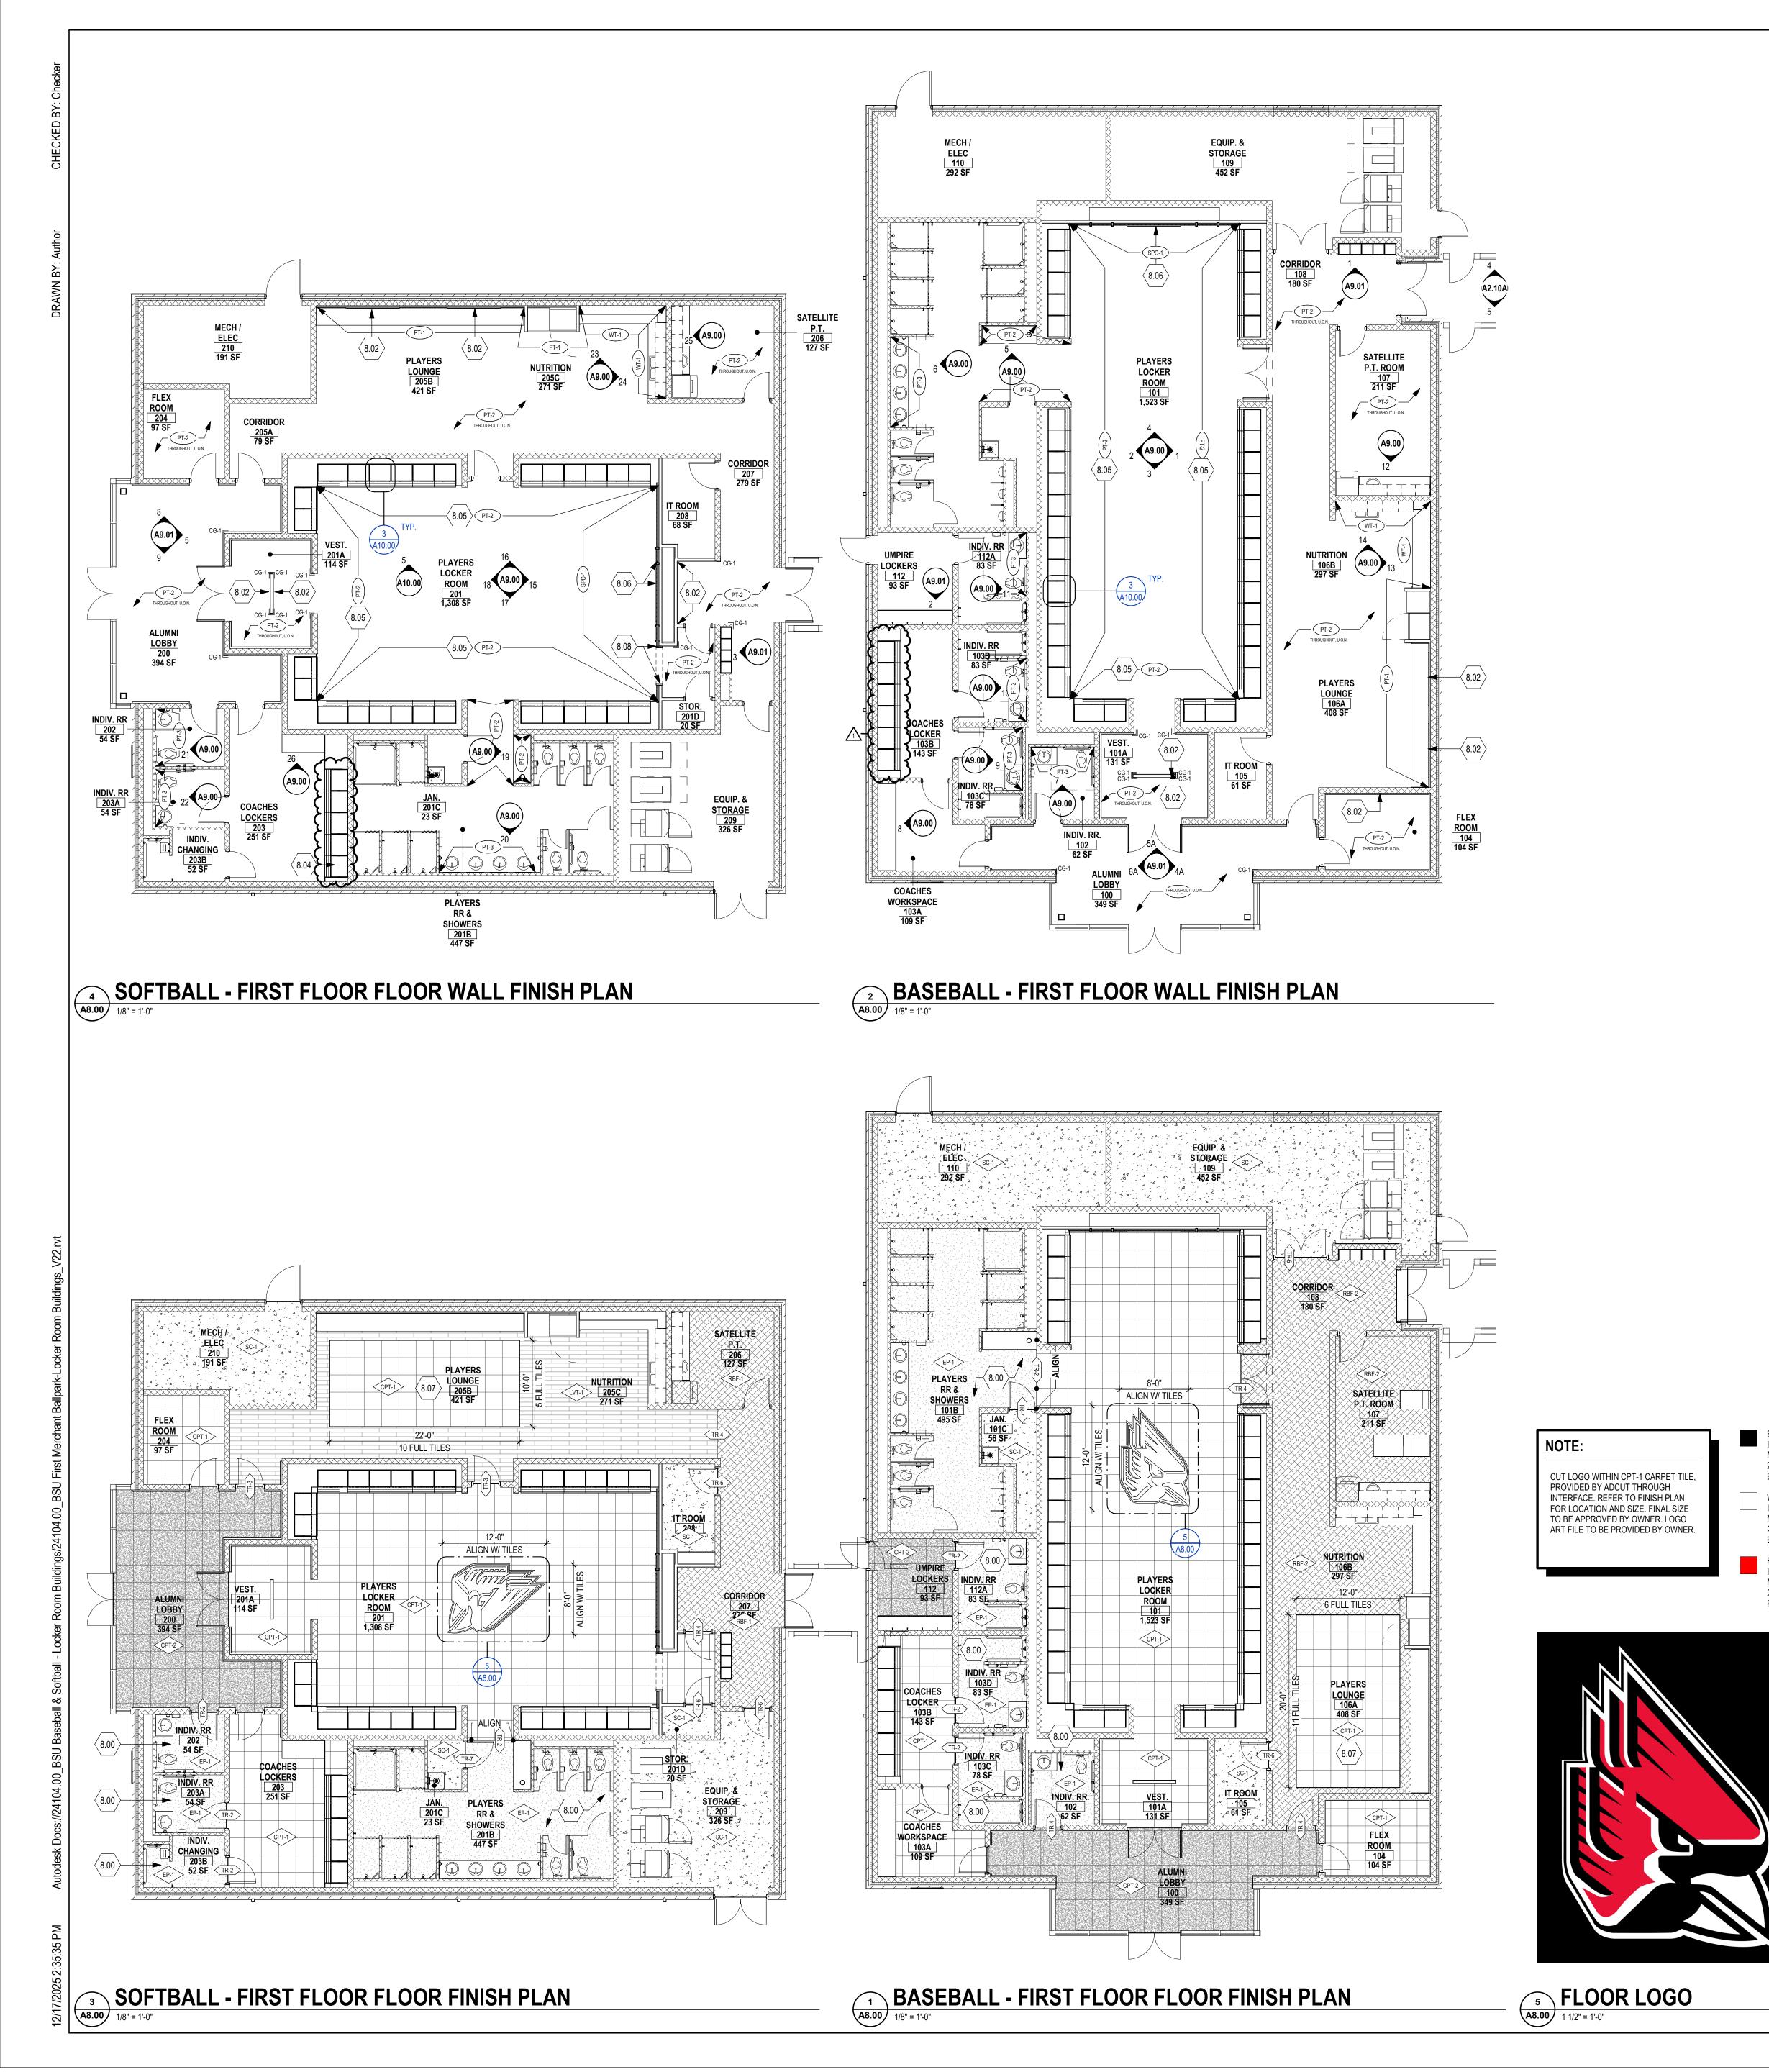
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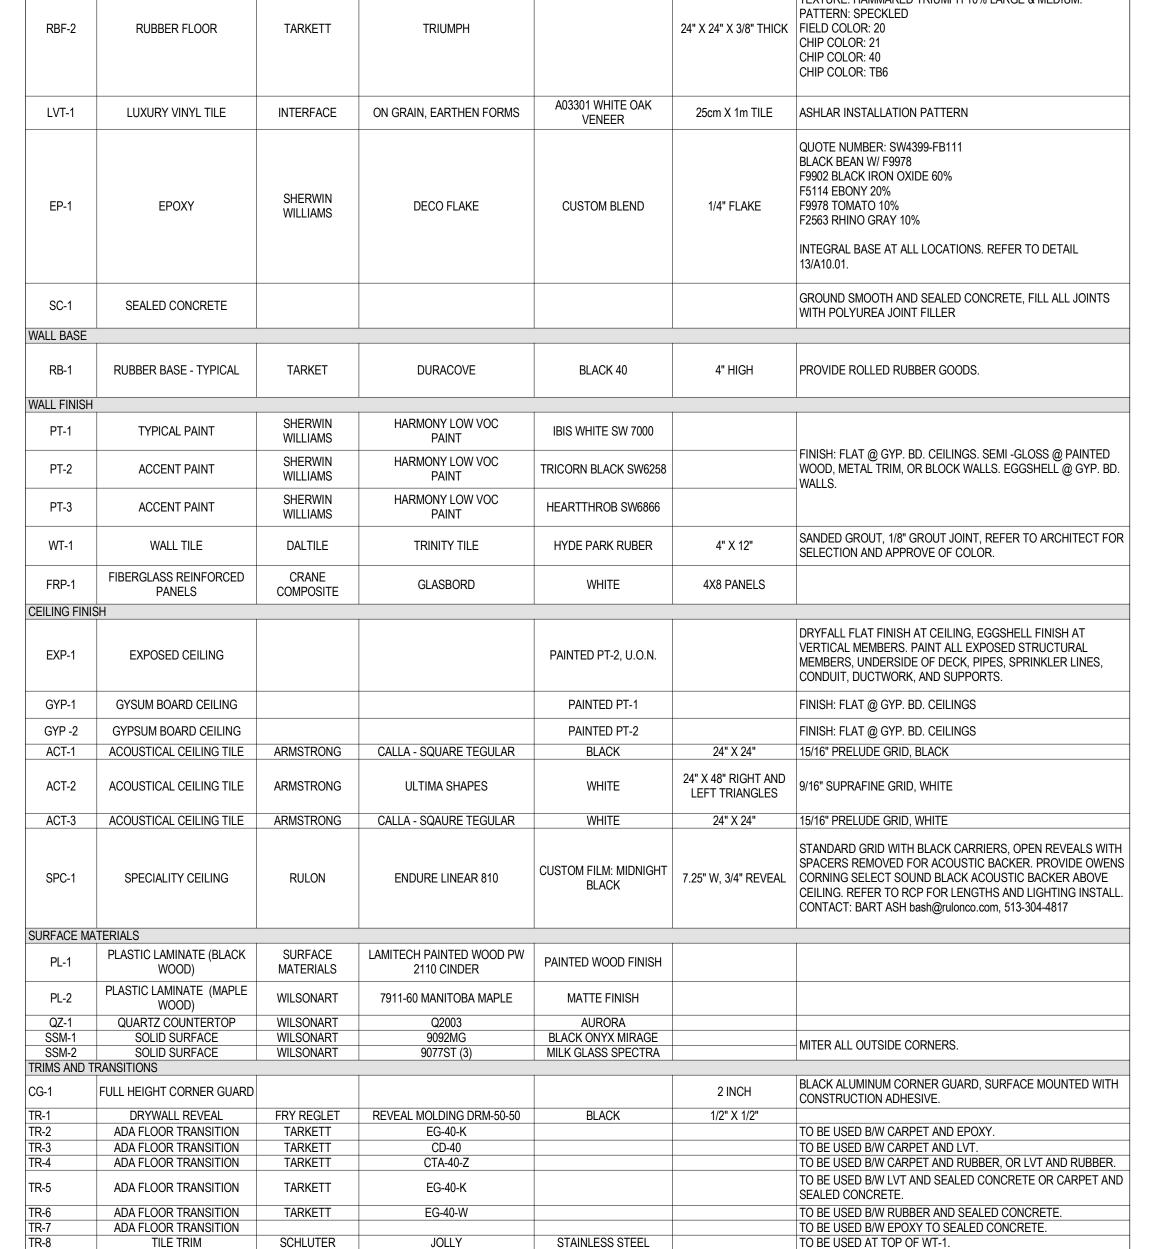
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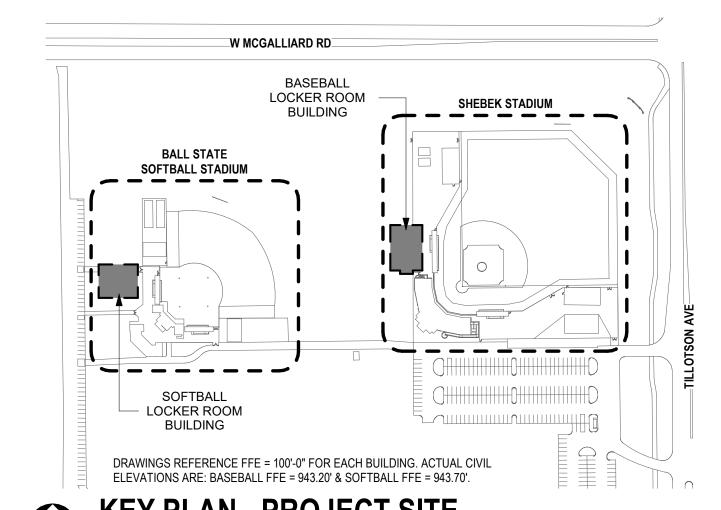
DRAWING TITLE: DOOR SCHEDULE & STOREFRONT **ELEVATIONS** 











**KEY PLAN - PROJECT SITE** 

DRAWING TITLE: FINISH PLANS

PROJECT NO.

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**A8.00** 

BUILDINGS

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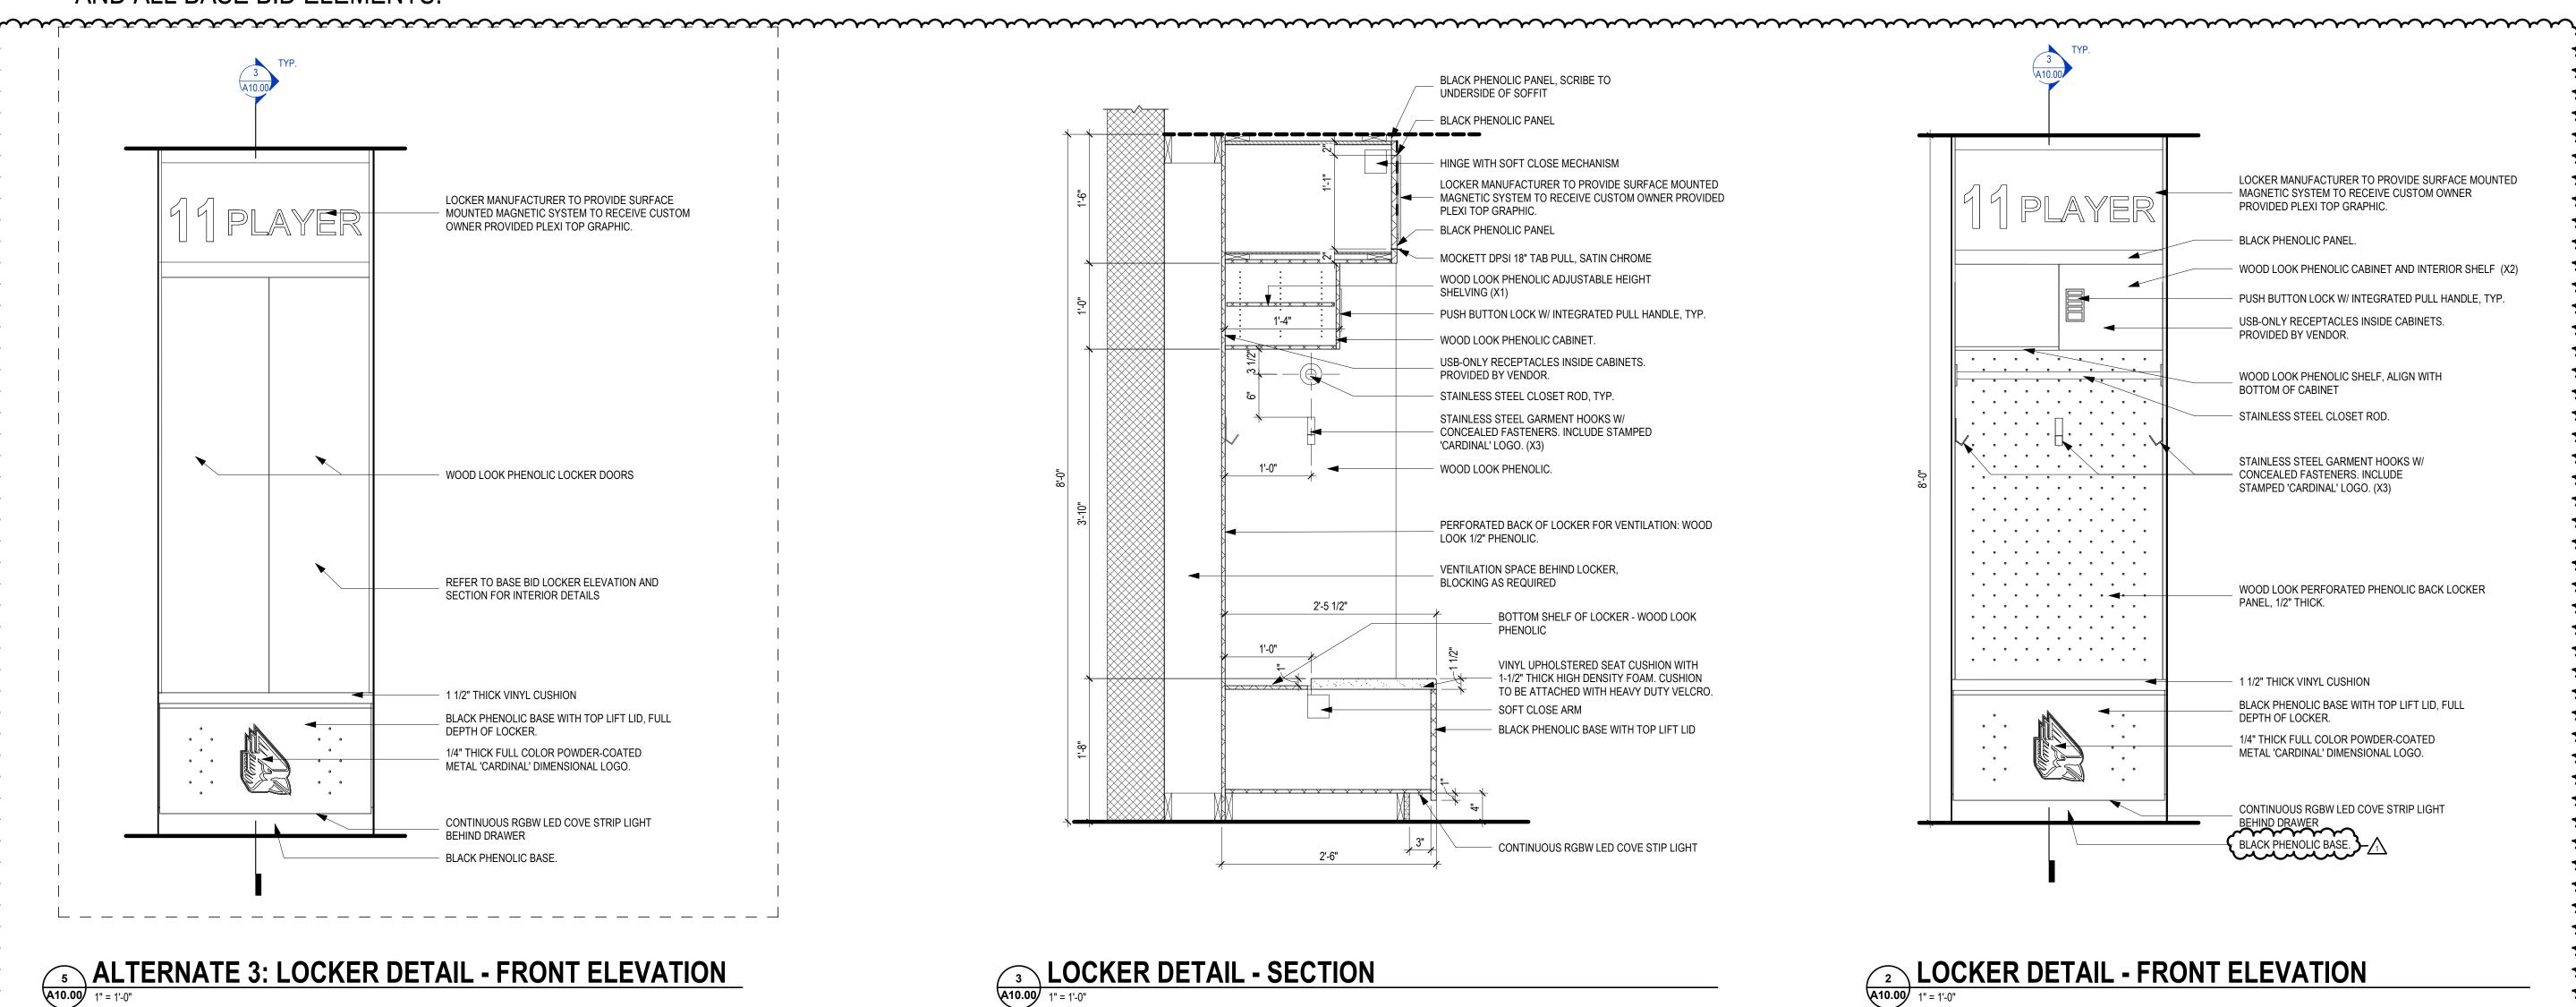
| 11 | player | 12 | player | 14 | player | 15 | player | 16 | player | 16 | player | 17 | player | 18 | player | 18 | player | 19 | player | • • • • + • + • • 


**ALTERNATE 3: PLAYER LOCKERS TO INCLUDE DOORS** AND ALL BASE BID ELEMENTS.


LOCKER ELEVATION


A10.00 1" = 1'-0"

**LOCKER DETAIL - SECTION** 



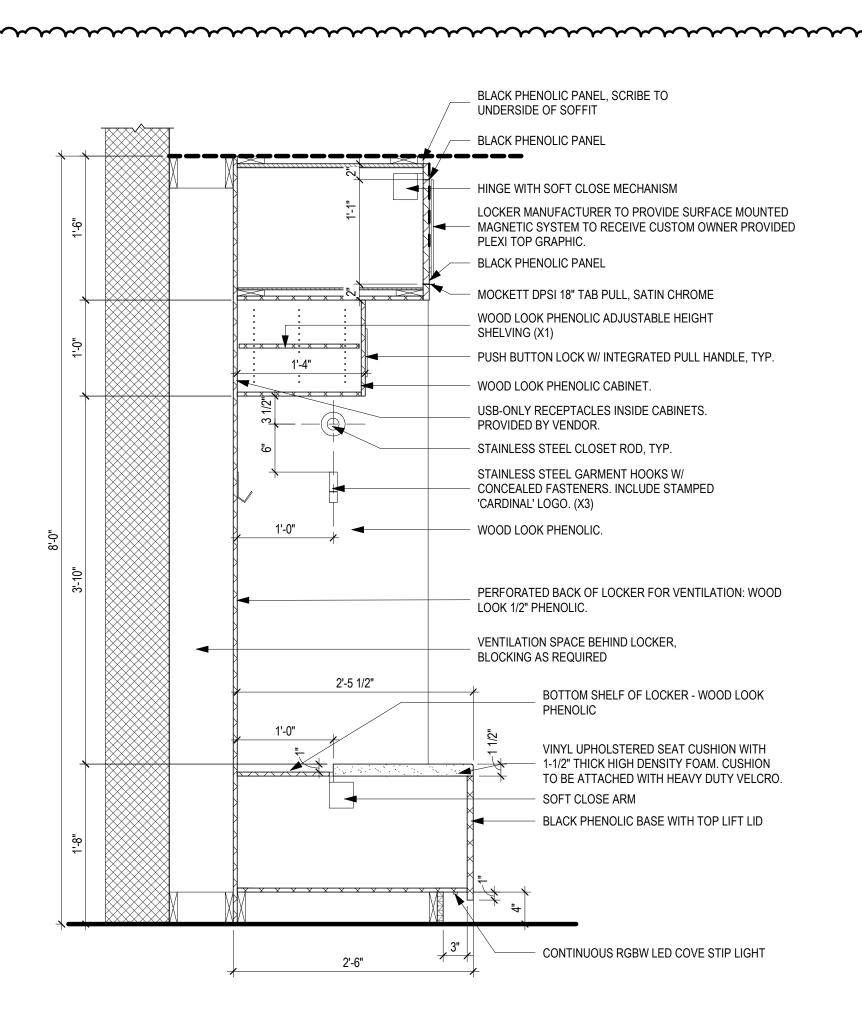

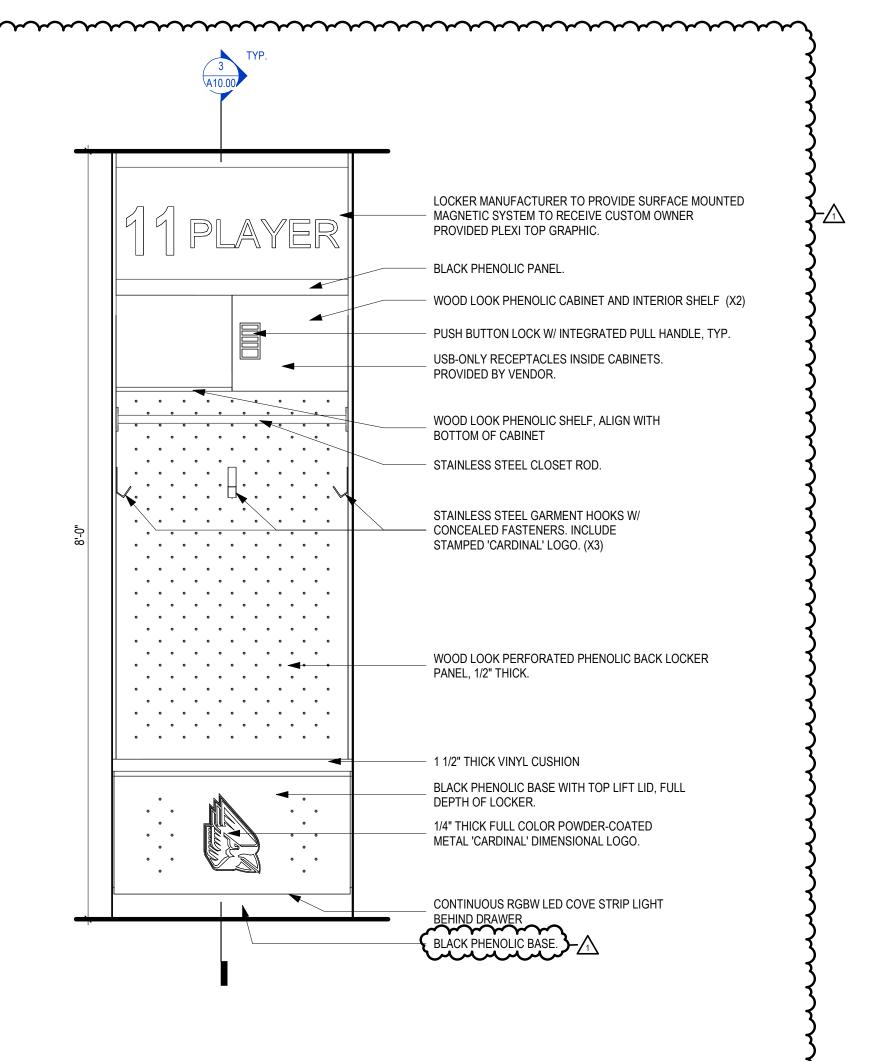

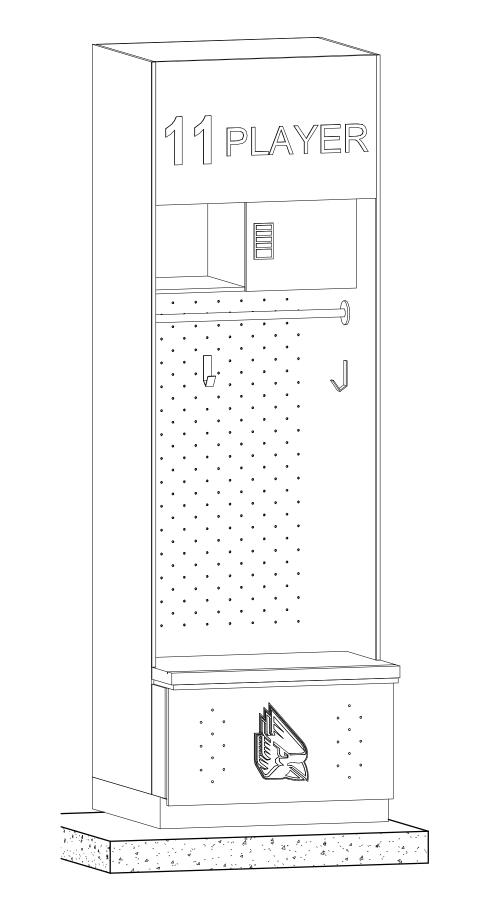

**LOCKER DETAIL - FRONT ELEVATION** 

LOCKER AXON